

PROJECT DESCRIPTION AND GOALS:

THE PROPOSED PROJECT IS THE HISTORIC RESTORATION OF THE THREE STREET BUILDING FACADES OF "ODD FELLOWS HALL" BUILDING; THE FACADES ALONG CENTRE, GRAND, AND BAXTER STREET. THE PROJECT'S GOALS ARE TO REVITALIZE THE BUILDING'S AESTHETICS & HISTORIC APPEARANCE IN ORDER TO RESTORE IT TO IT'S MAJESTIC ORIGINAL SPLENDOR.

RESTORING THE STOREFRONTS WILL INVOLVE REMOVING UNSIGHTLY AND NON-HISTORICALLY SYMPATHETIC ELEMENTS, REMOVAL OF ALL EXISTING ROLL DOWN GATES, EXISTING ENTRY DOORS, EXISTING STOREFRONTS, EXISTING VENTS, BROKEN WINDOWS, WINDOW BARS, REPAIRING DAMAGED PARTS, RESTORING STOREFRONTS TO AS CLOSE AN APPROXIMATION OF THEIR ORIGINAL LOOK AS POSSIBLE.

NOTE: THIS APPLICATION IS FILED TO REMOVE LPC VIOLATIONS 01/0211, 88/0080 & 15/0404.

BUILDING WIDE SCOPE OF WORK:

- 1. ENTIRE EXISTING FACADE TO BE CLEANED AND PATCHED REQUIRED. STUCCO MATERIAL TO BE APPLIED AS NEEDED TO RESTORE ORIGINAL HISTORIC CONDITION. REFER TO PLANS FOR PAINT SPECS.
- CORNICE AND LINTELS AT 1st FLOOR TO BE SCRAPED AND PAINTED AS REQUIRED.
- 3. CORNICE AT 4th FLOOR TO BE REPAIRED WHERE NECESSARY, SCRAPED AND PAINTED.
- 4. REMOVE PAINT AND BRICK ABOVE 5th FLOOR WINDOWS. USE PROSOCO-SURE KLEAN HEAVY DUTY PAINT STRIPPED OR SIMILAR NON-ABRASIVE CHEMICAL TREATMENT TO RETURN FACADE TO ITS ORIGINAL CONDITION. REFER TO PLAN, APPENDIX-1 FOR FURTHER INFO.

224 CENTRE STREET



ODD FELLOWS HALL AERIAL VIEW



MELTZER / COSTA AND ASSOCIATES

ARCHITECTS & ENGINEERS,LLP

175 GREAT NECK ROAD

GREAT NECK, NEW YORK 11021
TEL: (212) 688-6194 (516) 829-0278


224 CENTRE STREET NEW YORK, NY


LPC PRESENTATION

DRAWING


BUILDING CONTEXT & SCOPE OF WORK

P-1

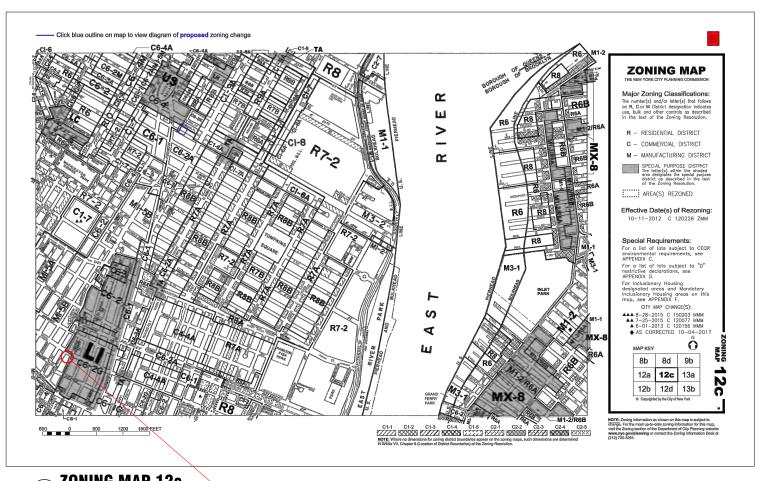

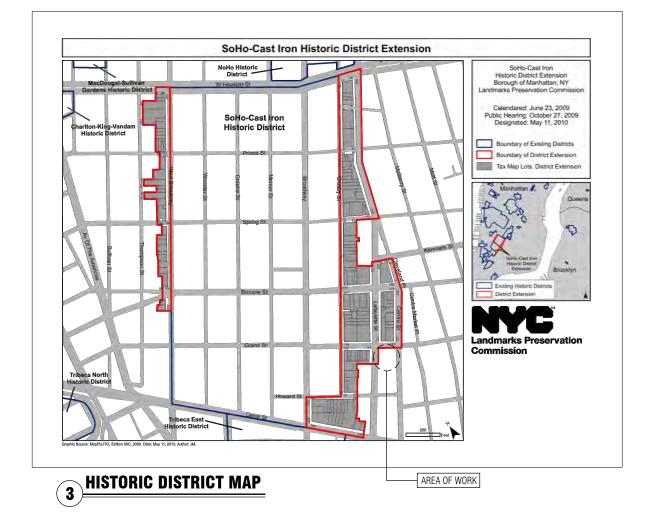

ZONING MAP 12c

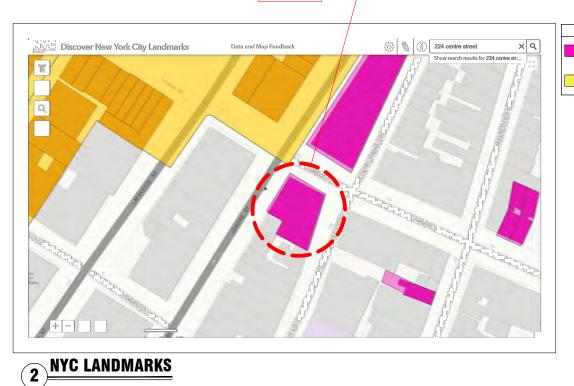

AREA OF WORK

224 CENTRE STREET, N.Y.C.

BLOCK: 235 LOT: 13

LEGEND

LANDMARKED BUILDING

SOHO HISTORIC DISTRICT

ZONE: M1-5B

DATE OF CONSTRUCTION: 1847 ARCHITECT: TRENCH & SNOOK

ORIGINAL FUNCTION: COMMERCIAL/INDUSTRIAL **CURRENT FUNCTION: RESIDENTIAL**

STYLE: ANGLO-ITALIAN

STORIES: 6

STRUCTURAL/MATERIAL:

BRIEF HISTORY:

THE ODD FELLOWS HALL LOCATED AT 165-171 GRAND STREET BETWEEN CENTRE AND BAXTER STREET IS IN THE NEIGHBORHOOD OF LITTLE ITALY IN MANHATTAN, NEW YORK CITY. COMMISSIONED BY THE INDEPENDENT ORDER OF ODD FELLOWS, A FRATERNAL ORGANIZATION FOUNDED TO BENEFIT THE SICK AND ORPHANED ESTABLISHED IN NEW YORK IN 1844.

THIS BUILDING WAS DESIGNED BY THE FIRM TRENCH & SNOOK IN AN ANGLO ITALIANATE STYLE, WAS STARTED IN 1847, COMPLETED IN 1848. IN 1881 THE MANSARD ROOF WAS ADDED BY DESIGNER JOHN BUCKINGHAM.

IN 1982 LPC DESIGNATED THIS BUILDING, AND IT WAS ADDED TO THE REGISTER OF HISTORIC PLACES IN 1983

PRESENT CONDITION OF THE PROPERTY:

ALL OF THE STOREFRONTS HAVE BEEN "MODERNIZED" THROUGHOUT THE LAST 30 YEARS. SOME OF THE BUILDING HAS BECOME LOFT SPACES FOR ARTISTS, AS WELL AS LIVING SPACES.



MELTZER / COSTA AND ASSOCIATES

ARCHITECTS & ENGINEERS,LLP 175 GREAT NECK ROAD GRFAT NECK. NEW YORK 11021 TEL: (212) 688-6194 (516) 829-0278

PROJECT TITLE

224 CENTRE STREET **NEW YORK, NY**

LPC PRESENTATION

ZONING & DISTRICT INFORMATION



1850'S DRAWING 2018 PHOTO 1970'S PHOTO



1850'S DRAWING



MELTZER / COSTA AND ASSOCIATES ARCHITECTS & ENGINEERS,LLP 175 GREAT NECK ROAD GREAT NECK, NEW YORK 11021 TEL: (212) 688-6194 (516) 829-0278

PROJECT TITLE

224 CENTRE STREET NEW YORK, NY

LPC PRESENTATION

DRAWING TITLE

HISTORICAL PHOTOS

P-3



CENTRE STREET **BAXTER STREET GRAND STREET**



MELTZER / COSTA AND ASSOCIATES ARCHITECTS & ENGINEERS,LLP 175 GREAT NECK ROAD GREAT NECK, NEW YORK 11021 TEL: (212) 688-6194 (516) 829-0278

224 CENTRE STREET NEW YORK, NY

LPC PRESENTATION

DRAWING TITLE

EXISTING PHOTOS

BUILDING INFORMATION			
ADDRESS	224 CENTRE ST., NEW YORK, NY, 10013		
BLOCK	235		
LOT	13		
MAP#	12C		
ZONE	M1-B5		
OCCUPANCY GROUP	COM		
CONSTRUCTION CLASS	1C		
LOFT BOARD IMD REGISTRATION No.	10100		

PROGRESS INSPECTION (2014)	
DIR-14 FINAL INSPECTION	DIR 14/75
CDECIAL INCDECTION (004.4)	

SPECIAL INSPECTION (2014)			
	STRUCTURAL STABILITY - EXISTING BUILDINGS	BC 1704.20	
	MECHANICAL DEMOLITION	BC 1704.20	

TENANT PROTECTION PLAN (28-104.8.4) 2016 CODE THE ELEMENTS OF THE TENANT PROTECTION PLAN MAY VARY DEPENDING ON THE NATURE AND SCOPE OF THE

WORK BUT AT A MINIMUM SHALL MAKE DETAILED AND SPECIFIC PROVISIONS FOR:

- EGRESS. AT ALL TIMES IN THE COURSE OF CONSTRUCTION PROVISION SHALL BE MADE FOR ADEQUATE EGRESS AS REQUIRED BY THIS CODE AND THE TENANT PROTECTION PLAN SHALL IDENTIFY THE EGRESS THAT WILL BE PROVIDED. REQUIRED EGRESS SHALL NOT BE OBSTRUCTED AT ANY TIME EXCEPT WHERE
- FIRE SAFETY. ALL NECESSARY LAWS AND CONTROLS, INCLUDING THOSE WITH RESPECT TO OCCUPIED DWELLINGS, AS WELL AS ADDITIONAL SAFETY MEASURES NECESSITATED BY THE CONSTRUCTION SHALL
- HEALTH REQUIREMENTS. SPECIFICATION OF METHODS TO BE USED FOR CONTROL OF DUST, DISPOSAL OF CONSTRUCTION DEBRIS, PEST CONTROL AND MAINTENANCE OF SANITARY FACILITIES, AND LIMITATION OF NOISE TO ACCEPTABLE LEVELS SHALL BE INCLUDED. 3.1. THERE SHALL BE INCLUDED A STATEMENT OF COMPLIANCE WITH APPLICABLE PROVISIONS OF LAV RELATING TO LEAD AND ASBESTOS.
- COMPLIANCE WITH HOUSING STANDARDS. THE REQUIREMENTS OF THE NEW YORK CITY HOUSING MAINTENANCE CODE, AND, WHERE APPLICABLE, THE NEW YORK STATE MULTIPLE DWELLING LAW SHALL
- STRUCTURAL SAFETY. NO STRUCTURAL WORK SHALL BE DONE THAT MAY ENDANGER THE OCCUPANTS.
- NOISE RESTRICTIONS. WHERE HOURS OF THE DAY OR THE DAYS OF THE WEEK IN WHICH CONSTRUCTION WORK MAY BE UNDERTAKEN ARE LIMITED PURSUANT TO THE NEW YORK CITY NOISE CONTROL CODE, SUCH LIMITATIONS SHALL BE STATED

CONSTRUCTION CLASS - TABLE 3-4

CONSTRUCTION CLASS: IC (2 HR PROTECTED) EXT. SEPERATION:

PERMITTED: EXT. WALLS - 3' OR LESS - BEARING - 2 HR, NON - COMBUSTIBLE MIN. W/ 10% MAX. EXT OPNG. (FOOTNOTE "A") = .1(63'-10"X47'-2" WALL) = 301.1 SF PROPOSED: 0FT - 5FT SEPERATION, 2 HR, NON-COMBUSTIBLE, EXT OPNG. = 112 SF < 301.1 COMPLIES PERMITTED: 2 HR, COMBUSTIBLE MIN.

EXISTING: 2HR. COMBUSTIBLE - COMPLIES ENCLOSURE VERTICAL EXITS, SHAFTS, ETC: PERMITTED: 2HR. NON-COMBUSTIBLE MIN. EXISTING: 2 HR, NON-COMBUSTIBLE - COMPLIES

• COLUMNS, STRUC. MEMBERS, FLRS ETC: PERMITTED: 1.5 HR, COMB. MIN. EXISTING - 1.5 HR, NON-COMBUSTIBLE - COMPLIES FLOOR CONSTRUCTION INCL. BEAMS: PERMITTED: 1 HR. NON-COMBUSTIBLE

PERMITTED - 1 HR, NON-COMBUSTIBLE MIN. EXISTING - 1 HR, NON-COMBUSTIBLE - COMPLIES

EXISTING: 1 HR NON COMBUSTIBLE

NYCECC 2016 NOTE:

TO THE BEST OF MY KNOWLEDGE, BELIEF AND PROFESSIONAL JUDGMENT ALL WORK UNDER THIS APPLICATION IS EXEMPT FROM THE NYCECC IN THAT THE WORK IS AN ALTERATION OF A STATE OR NATIONAL HISTORIC

TEMPORARY SIDEWALK FENCE FILED UNDER APP #140263060

LIST OF DRAWINGS

ZONING INFO. PLOT PLAN, NOTES

PROPOSED CENTRE STREET PLAN, ELEVATION & PHOTOGRAPHS

A-102 PROPOSED GRAND STREET PLAN, ELEVATION & PHOTOGRAPHS

PROPOSED BAXTER STREET PLAN, ELEVATION & PHOTOGRAPHS

A-201 EXISTING & PROPOSED CENTRE STREET ELEVATION

EXISTING & PROPOSED GRAND STREET ELEVATION

EXISTING & PROPOSED BAXTER STREET ELEVATION


DOOR & WINDOW DETAILS A-204

DOOR & WINDOW DETAILS EXISTING & PROPOSED CELLAR VAULT PLAN

S-101 STRUCTURAL DETAILS

PAINT SCHEDULE

BENJAMIN MOORE: MOOR-O-MATIC COLOR SYSTEM - HC-58

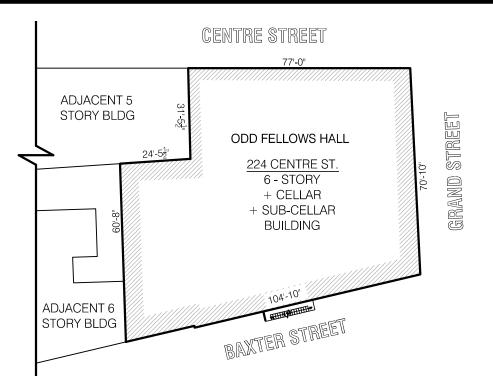

TO IT'S MAJESTIC ORIGINAL SPLENDOR.

SCOPE OF WORK

PROJECT DESCRIPTION AND GOALS THE PROPOSED PROJECT IS THE HISTORIC RESTORATION OF THE THREE STREET BUILDING FACADES OF "ODD FELLOWS HALL" BUILDING; THE FACADES ALONG CENTRE, GRAND, AND BAXTER STREET. THE PROJECT'S GOALS ARE TO REVITALIZE THE BUILDING'S AESTHETICS & HISTORIC APPEARANCE IN ORDER TO RESTORE IT

RESTORING THE STOREFRONTS WILL INVOLVE REMOVING UNSIGHTLY AND NON-HISTORICALLY SYMPATHETIC ELEMENTS, REMOVAL OF ALL EXISTING ROLL DOWN GATES, EXISTING ENTRY DOORS, EXISTING STOREFRONTS, EXISTING VENTS, BROKEN WINDOWS. WINDOW BARS. REPAIRING DAMAGED PARTS. RESTORING STOREFRONTS TO AS CLOSE AN APPROXIMATION OF THEIR ORIGINAL LOOK AS

NOTE: THIS APPLICATION IS FILED TO REMOVE LPC VIOLATIONS 01/0211, 88/0080 **&** 15/0404.

MASTER PLAN A VENTILATION PLAN IS TO BE PROPOSED AS A SOLUTION FOR ANY NEED FOR HVAC CURRENT & FUTURE AS NEEDED PER FLOOR AND UNITS.-SEE SHEETS A-203.00 & A-207.00

THE ODD FELLOWS HALL LOCATED AT 165-171 GRAND STREET BETWEEN CENTRE AND BAXTER STREET IS IN THE NEIGHBORHOOD OF LITTLE ITALY IN MANHATTAN, NEW YORK CITY. COMMISSIONED BY THE INDEPENDENT ORDER OF ODD FELLOWS, A FRATERNAL ORGANIZATION FOUNDED TO BENEFIT THE SICK AND ORPHANED ESTABLISHED IN NEW YORK IN 1844.

THIS BUILDING WAS DESIGNED BY THE FIRM TRENCH & SNOOK IN AN ANGLO ITALIANATE STYLE, WAS STARTED IN 1847, COMPLETED IN 1848. IN 1881 THE MANSARD ROOF WAS ADDED BY DESIGNER JOHN BUCKINGHAM.

IN 1982 LPC DESIGNATED THIS BUILDING, AND IT WAS ADDED TO THE REGISTER OF HISTORIC PLACES IN 1983.

PRESENT CONDITION OF THE PROPERTY:

ALL OF THE STOREFRONTS HAVE BEEN "MODERNIZED" THROUGHOUT THE LAST 30 YEARS. SOME OF THE BUILDING HAS BECOME LOFT SPACES FOR ARTISTS, AS WELL AS LIVING SPACES.

CONCRETE NOTES:

ALL CONCRETE WORK SHALL COMPLY WITH THE AMERICAN CONCRETE INSTITUTE ("ACI") "BUILDING CODE REQUIREMENTS FOR REINFORCED CONCRETE" ACI 318. AS MODIFIED BY SUBCHAPTER 10 ARTICLE 5 OF THE NYC 2. ALL CONCRETE WORK SHALL COMPLY WITH ACI 301-05 SPECIFICATIONS FOR STRUCTURAL CONCRETE FOR

3. CALCIUM CHLORIDE (OR ANY ADMIXTURE CONTAINING CHLORIDE SALTS) SHALL NOT BE USED IN CONCRETE. 4. UNLESS NOTED OTHERWISE, ALL CONCRETE SHALL BE NORMAL WEIGHT WITH A MINIMUM 28-DAY COMPRESSIVE STRENGTH OF 4,000 PSI AND A MAXIMUM WATER/CEMENT RATIO OF 0.50 BY WEIGHT, MAXIMUM SLUMP SHALL NE 4 IN. AIR-ENTRAINMENT SHALL BE 5.5% +/- 1%.

5. ALL BILLET REINFORCEMENT STEEL SHALL BE GRADE 60 (Fy = 60 ksi) AND SHALL CONFORM TO ASTM SPECIFICATION OF DEFORMED AND PLAIN BILLET STEEL BARS FOR CONCRETE REINFORCEMENT, ASTM A615. 6. ALL WELDED WIRE FABRIC SHALL CONFORM TO THE STANDARDS OF ASTM A82 AND A185. ALL WELDED WIRE FABRIC SHALL BE LAPPED TWO (2) FULL MESH PANELS AT ENDS AND SIDES AND TIED SECURELY, UNLESS OTHERWISE NOTED, MINIMUM WWF 4 X 4 - W2.9 X W2.9 SHALL BE PROVIDED UNLESS OTHERWISE NOTED. 7. ALL REINFORCING STEEL SHALL BE SECURELY HELD SECURELY IN PLACE DURING CONCRETE PLACEMENT, IF REQUIRED, CHAIRS, REINFORCEMENT BARS, TIES, SPACERS OR ADDITIONAL BARS AND STIRRUPS SHALL BE PROVIDED TO FURNISH SUPPORT FOR ALL BARS, ALL ANCILLARY SUPPORT ELEMENTS SHALL BE MADE FROM

NON-CORRODIBLE MATERIALS. 8. GROUT FOR STEEL COLUMN BASES TO BE NON-SHRINK WITH fc =5,000 p.s.i. 9. ALL LAP SPLICES SHALL BE 1.7Ld UNLESS OTHERWISE NOTED.

10. DOWELS SHALL BE DRILLED IN AND SHALL HAVE THE MINIMUM EMBEDMENT INDICATED. ANCHOR DOWELS USING SHRINK-GROUT 212 (OR EQUIVALENT). 11. APPLY SIKA ARMATEC 110 BONDING AGENT (OR EQUIVALENT) ON ALL HARD CONCRETE SURFACES TO

RECEIVE NEW CONCRETE. FOLLOW MANUFACTURER SPECIFICATIONS. 12. ALL SLABS SHALL BE TROWEL FINISHED.

13. ALL EXPOSED CONCRETE TO BE AIR ENTRAINED. 14. ALL PLUMBING SLOTS TO BE FILLED WITH CONCRETE TO THE SAME DEPTH AS THE SLAB AFTER PIPING IS

COLOR CHIP

BENJAMIN MOOR: MOOR-O-MATIC COLOR SYSTEM: HC-58

APPENDIX - 1

- 1. PAINT SHALL BE REMOVED FROM THE FACADE OF THE BUILDING BY POWER WASHING. APPLYING NECESSARY APPLICATIONS OF COATING REMOVAL CHEMICAL (PROSOCO OR EQUIVALENT) TO PAINTED AREA AS PER MANUFACTURE'S SPECIFICATION. SEE APENDIX-1
- POWER WASH FACADE AT A PRESSURE NOT TO EXCEED 500 PSI.
- REPEAT PROCESS AS REQUIRED.
- 4. CONTRACTOR SHALL USE TEKTON TAPING KNIFE OR EQUIVALENT FOR LIGHT SCRAPING ONLY AS REQUIRED TO REMOVE PAINT WITHOUT CAUSING ANY DAMAGE TO BRICK

RESPONSIBILITY OF THE CONTRACTOR TO REFER TO THE PRODUCT DATA SHEET AND MATERIAL SAFETY DATA SHEET FOR ADDITIONAL RECOMMENDATIONS AND SAFETY **INFORMATION**

TEST AREA:

TEST A MINIMUM 4 ft. BY 4 ft. AREA ON EACH TYPE OF MASONRY. USE MANUFACTURER'S APPLICATION INSTRUCTIONS. LET THE TEST PANEL DRY 3 TO 7 DAYS BEFORE INSPECTION. KEEP TEST PANELS AVAILABLE FOR COMPARISON THROUGHOUT THE CLEANING PROJECT.

TECHNICAL DATA: SPECIFIC GRAVITY: 1.293

TOTAL SOLIDS: ACTIVE CONTENT:

200 degrees F (> 93 degrees C) ASTM D3278 -22 degrees F (< -30 degrees C) SHELF LIFE: 2 years in tightly sealed, unopened container.

- Product efficiency is reduced during cold weather. surface and air temperatures should be at least 50 degrees f (10 degrees c) during application.
- Contains highly alkaline ingredients. neutralize treated surfaces with sure Klean® Limestone & Masonry Afterwash or other appropriate Sure Klean® cleaner.
- Do not use wood. Alkaline ingredients raise the grain of wood and may interfere with paint adhesion or performance.
- Not appropriate for metal surfaces.

APPLICATION

BEFORE APPLYING, READ "PREPARATION" AND "SAFETY INFORMATION" SECTIONS IN THE MANUFACTURE'S PRODUCT DATA SHEET FOR HEAVY DUTY PAINT STRIPPER. DO NOT DILUTE OR ALTER. STIR OR MIX WELL BEFORE USE.

- 1. REMOVE ALL LOOSE AND PEELING PAINT USING PRESSURE WATER OR SCRAPER. LET SURFACE DRY THOROUGHLY.
- APPLY APPROXIMATELY 1/8 INCH COAT OF STRIPPER.
- LEAVE PAINT STRIPPER ON THE SURFACE UNTIL THE PAINT IS ODIOUSLY "LIFTED" OR DISSOLVED. IF STRIPPER IS LEFT ON THE SURFACE UNATTENDED, TAKE PRECAUTIONS TO PREVENT PEDESTRIANS FROM COMING NEAR TREATED
- 4. USING PRESSURE-RISING EQUIPMENT AND WORKING FROM THE BOTTOM OF THE TREATED SURFACE TO THE TOP, THOROUGHLY RINSE THE STRIPPER AND SOLUBILIZED PAINT FROM THE SURFACE. USE AS MUCH WATER AS POSSIBLE THE BEST COMBINATION OF RINSING PRESSURE AND WATER VOLUME IS PROVIDED BY MASONRY WASHING EQUIPMENT GENERATING 400-1000 PSI WITH A WATER FLOW RATE OF 6-8 GALLONS PER MINUTE DELIVERED THROUGH A 15-45 DEGREE FAN SPRAY TIP. EQUIPMENT SHOULD BE ADJUSTABLE TO REDUCE WATER FLOW RATE AND RINSING PRESSURE AS REQUIRED FOR CONTROLLED CLEANING OF MORE SENSITIVE SURFACES. SEE ALSO "EQUIPMENT" SECTION OF THE PRODUCT DATA SHEET.
- REAPPLY STRIPPER IF NEEDED. SHORTER DWELL TIMES ARE USUALLY ENOUGH ON SECOND APPLICATIONS WHERE ONLY A LITTLE PAINT REMAINS.


SURFACE NEUTRALIZATION


WHEN ALL PAINT HAS BEEN REMOVED, TREATED SURFACES MOST BE NEUTRALIZED BY APPLYING A SOLUTION OF SURE KLEAN® LIMESTONE & MASONRY AFTERWASH PURSUANT TO THE APPLICATION INSTRUCTIONS ON THE PRODUCT LABEL.

- BRUSH APPLY THE PREPARED AFTERWASH TO TREATED SURFACES IN A GENTLE SCRUBBING MANNER. LET AFTERWASH STAY ON THE SURFACE 3 TO 5 MINUTES.
- 7. RINSE THE TREATED AREA THOROUGHLY. REMOVE ALL TRACES OF PASTE RESIDUE AND SOLUBILIZED PAINT COATINGS. NOTE: WHEN RISING, HEATED WATER (150°-180°F; 65°-82°C) IMPROVES REMOVAL EFFICIENCY AND REDUCES RINSE WATER AND LIQUID WASTE.
- 8. USING pH PAPERS, pH PEN OR pH INDICATOR SOLUTIONS, CHECK TREATED SURFACES TO ENSURE NEUTRALIZATION HAS BEEN ACHIEVED. REPEAT STEPS 6-7 ABOVE IF NEEDED UNTIL SURFACE pH IS 5.0 TO 9.0.
- 9. LET NEUTRALIZED SURFACE DRY THOROUGHLY. BEFORE APPLYING NEW SURFACE COATINGS, CHECK THE CLEANED SURFACE AGAIN USING pH PAPERS, pH PEN OR pH INDICATOR SOLUTIONS. CHECK THAT SURFACE pH IS NEUTRAL. INADEQUATE NEUTRALIZATION MAY CAUSE SURFACE DISCOLORATION OR FAILURE OF NEW SURFACE COATINGS.
- NOTE: WHEN REMOVING 15-20 COATS OF PAINT, A SECOND APPLICATION DIRECTLY OVER THE FIRST APPLICATION (BEFORE RINSING) OFTEN IMPROVES STRIPPING EFFICIENCY. LET THE FIRST COAT DWELL FOR THE PREDETERMINED TIME BEFORE THE SECOND APPLICATION.
- SPECIFIED NOTE: FAILURE TO NEUTRALIZE THE SURFACE MAY RESULT IN AN ALKALINE RESIDUE THAT MAY CAUSE UNSIGHTLY WHITE HAZE AND INTERFERE WITH ADHESION OF CLEAR SEALERS AND PAINT COATINGS. IF THE WASTE GENERATED THROUGH PIANT STRIPPING OPERATIONS IS CLASSIFIED AS "HAZARDOUS" CONTRACTORS MUST CONSULT AND COMPLY WITH CURRENT FEDERAL, STATE AND LOCAL REGULATIONS REGARDING CONTAINMENT, TRANSPORT AND DISPOSAL OF HAZARDOUS WASTE. SEE ALSO "LEAD-BASED PAINT REMOVAL" SECTION OF THE MANUFACTURER'S PRODUCT DATA SHEET.

ODD FELLOWS HALL

224 CENTRE STREET, NEW YORK NY.

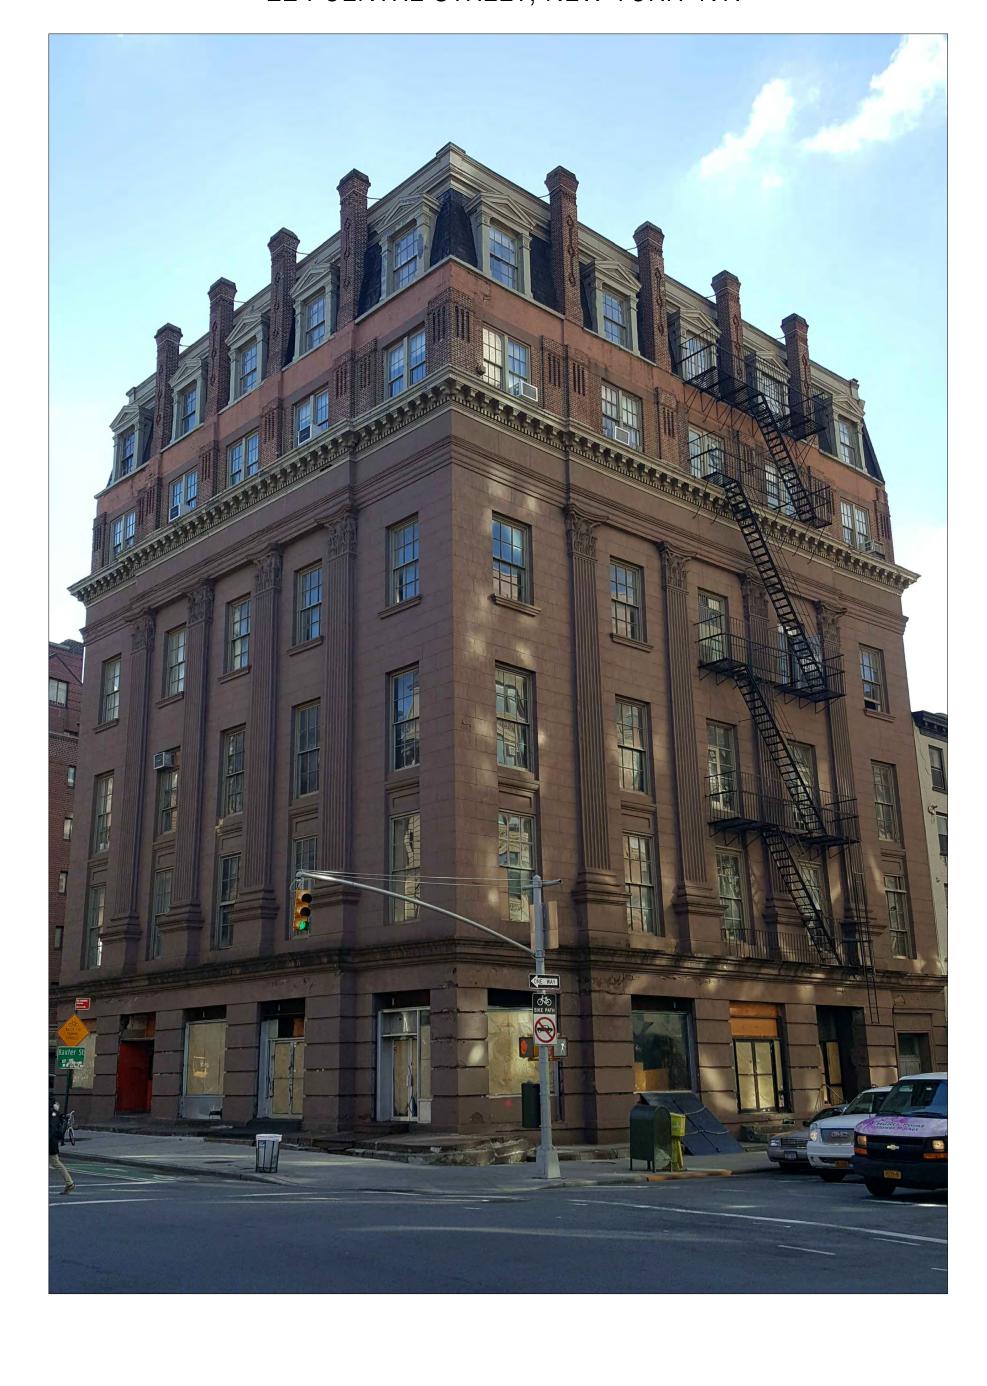

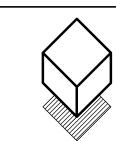

MELTZER / COSTA & ASSOCIATES **ARCHITECTURE & ENGINEERING** 175 GREAT NECK ROAD

GREAT NECK, NEW YORK 11021 TEL: (516) 829-0278 (212) 688-6194


CONTRACTOR SHALL VERIFY ALL FIELD CONDITIONS FIT AND QUALITY OF WORK. NO ALLOWANCES SHALL BE MADE IN BEHALF OF THE CONTRACTOR FOR ANY ERROR OR NEGLECT ON HIS PART.


IGGGE			
Έ	#	DESCRIPTION	
018	1	SUBMIT TO LPC	

PROJECT TITLE:

224 CENTRE ST. **NEW YORK, NY**

ZONING INFO, PLOT PLAN, **NOTES**

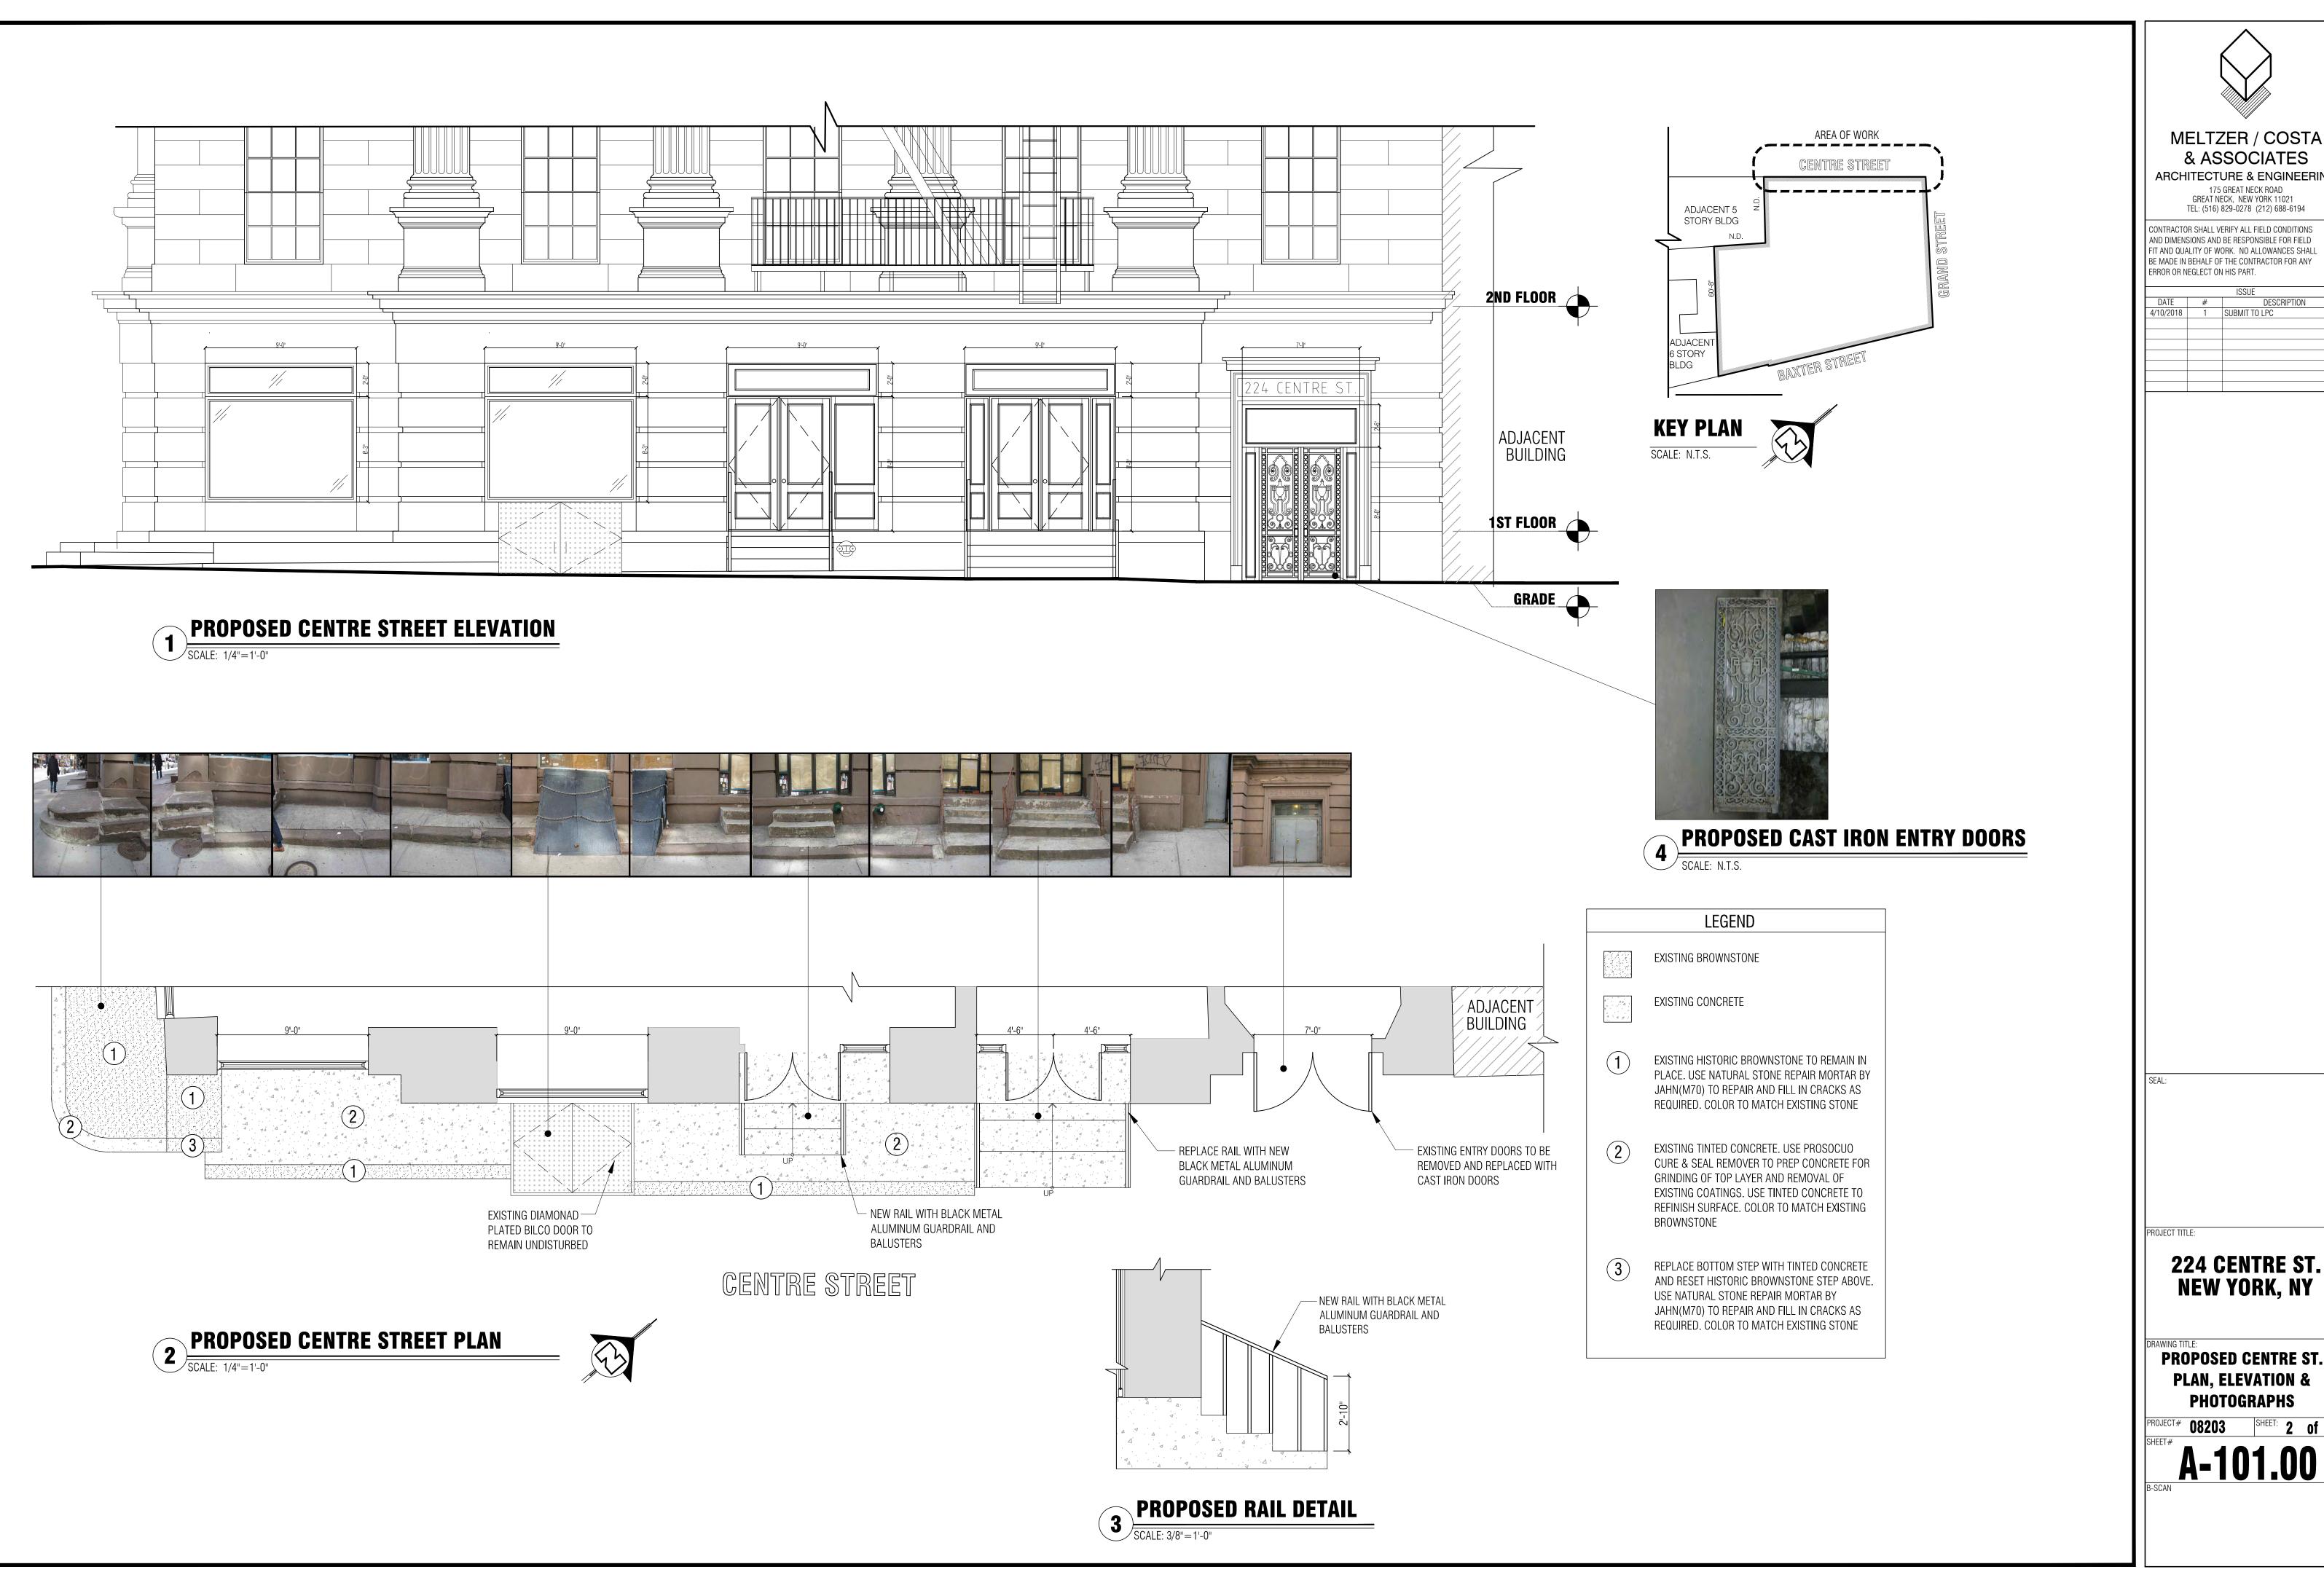

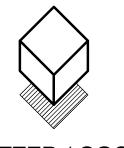

& ASSOCIATES ARCHITECTURE & ENGINEERING

CONTRACTOR SHALL VERIFY ALL FIELD CONDITIONS AND DIMENSIONS AND BE RESPONSIBLE FOR FIELD FIT AND QUALITY OF WORK. NO ALLOWANCES SHALL


10002			
DATE	#	DESCRIPTION	
4/10/2018	1	SUBMIT TO LPC	


224 CENTRE ST. **NEW YORK, NY**

PROPOSED CENTRE ST. **PLAN, ELEVATION & PHOTOGRAPHS**


PROJECT# **08203** SHEET: **2 of 12**

A-101.00

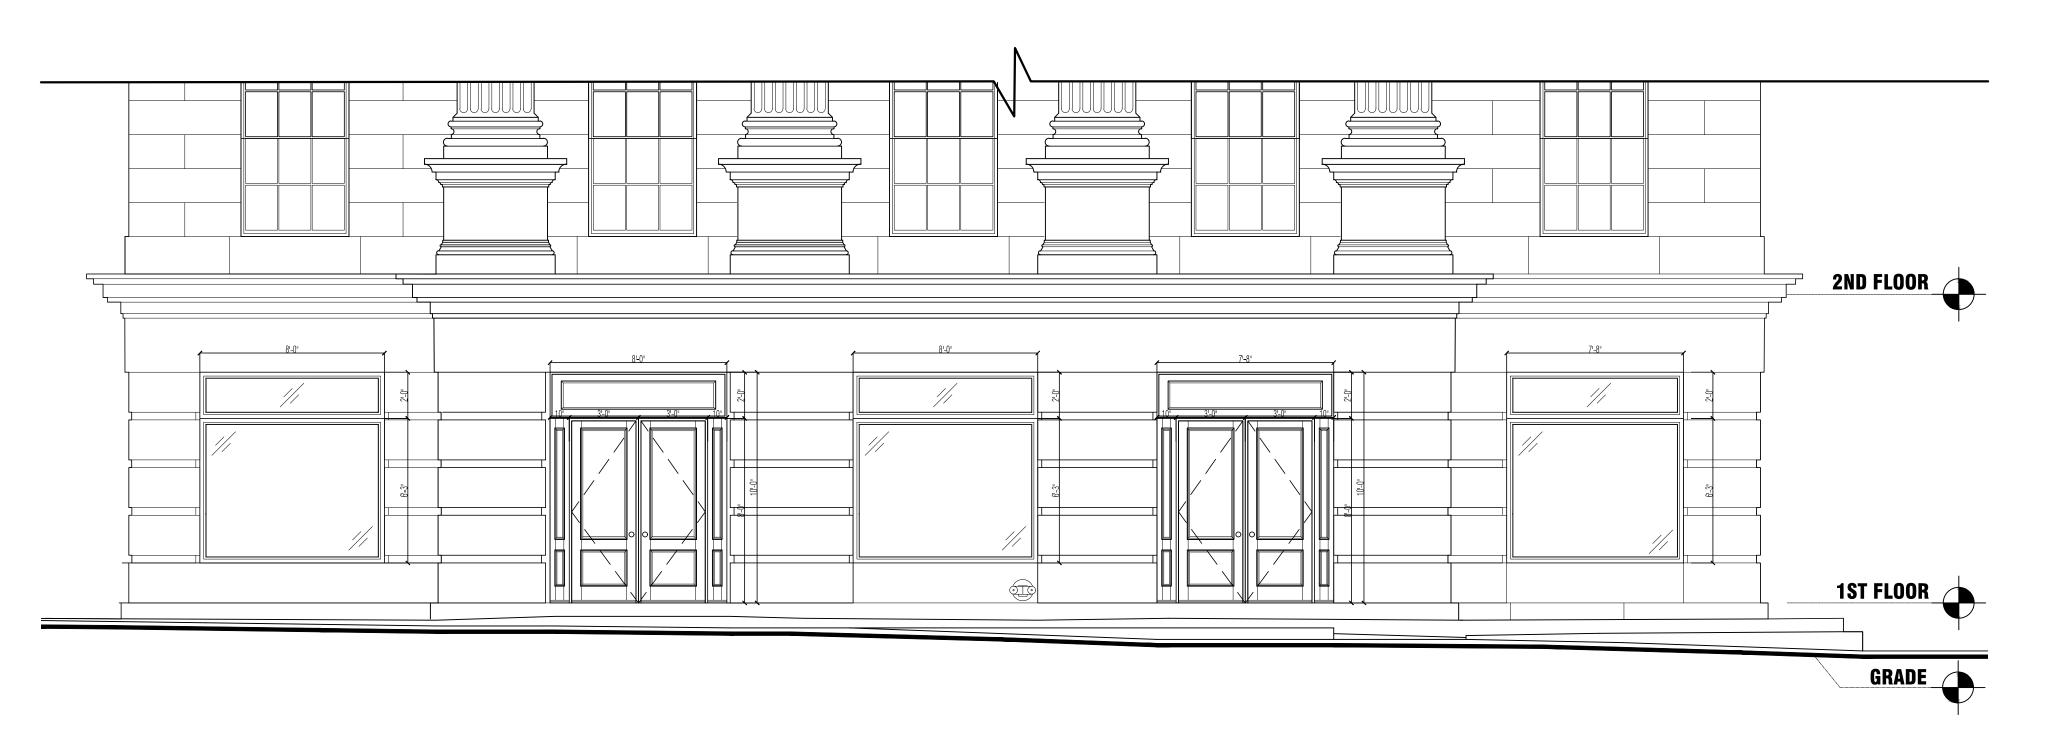

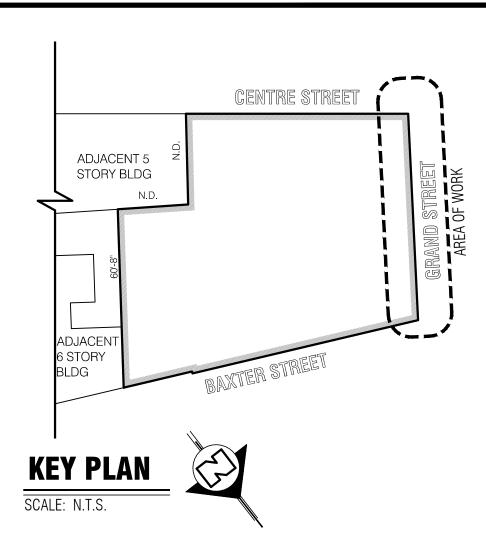

PROPOSED GRAND STREET ELEVATION SCALE: 1/4"=1'-0"

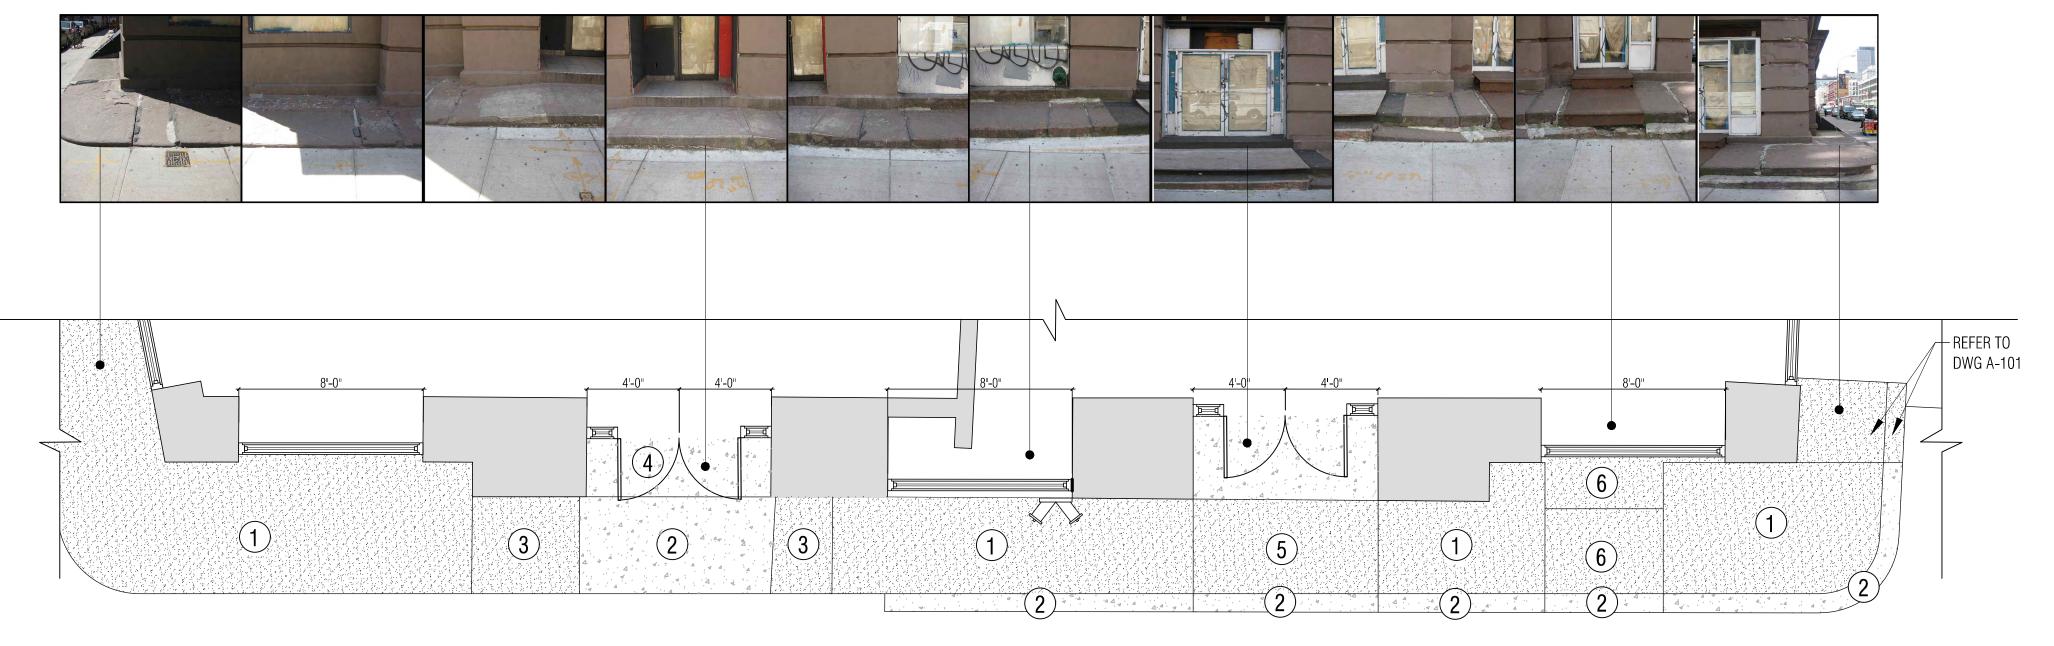

GRAND STREET




LEGEND

EXISTING BROWNSTONE

EXISTING CONCRETE

- EXISTING HISTORIC BROWNSTONE TO REMAIN IN PLACE. USE NATURAL STONE REPAIR MORTAR BY JAHN(M70) TO REPAIR AND FILL IN CRACKS AS REQUIRED. COLOR TO MATCH EXISTING STONE
- 2 EXISTING TINTED CONCRETE. USE PROSOCUO CURE & SEAL REMOVER TO PREP CONCRETE FOR GRINDING OF TOP LAYER AND REMOVAL OF EXISTING COATINGS. USE TINTED CONCRETE TO REFINISH SURFACE. COLOR TO MATCH EXISTING BROWNSTONE
- REMOVE CONCRETE RAMP INFILL AND USE NATURAL STONE REPAIR MORTAR BY JAHN (M70) TO REPAIR AND FILL IN CRACKS AS REQUIRED ON EXISTING BROWNSTONE BELOW. COLOR TO MATCH EXISTING BROWNSTONE.
- REMOVE TILE AND USE TINTED CONCRETE TO REFINISH SURFACE. COLOR TO MATCH EXISTING BROWNSTONE.
- REMOVE PLYWOOD AND CARPET. CONTRACTOR
 TO CONTACT ARCHITECT TO ASSES CONDITION OF
 MATERIALS BELOW PLYWOOD AND DECIDE UPON
 APPROPRIATE COURSE OF ACTION. ARTCHITECT
 TO CONTACT LPC.
- REMOVE DIAMOND PLATE AND AND USE NATURAL STONE REPAIR MORTAR BY JAHN (M70) TO REPAIR AND FILL IN CRACKS AS REQUIRED ON EXISTING BROWNSTONE. COLOR TO MATCH EXISTING BROWNSTONE.

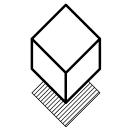

MELTZER / COSTA & ASSOCIATES ARCHITECTURE & ENGINEERING

175 GREAT NECK ROAD
GREAT NECK, NEW YORK 11021
TEL: (516) 829-0278 (212) 688-6194

CONTRACTOR SHALL VERIFY ALL FIELD CONDITIONS
AND DIMENSIONS AND BE RESPONSIBLE FOR FIELD
FIT AND QUALITY OF WORK. NO ALLOWANCES SHALL

BE MADE IN BEHALF OF THE CONTRACTOR FOR ANY

ERROR OR NEGLECT ON HIS PART.

ISSUE			
DATE	#	DESCRIPTION	
4/10/2018	1	SUBMIT TO LPC	

SEAL:

PROJECT TITLE:


224 CENTRE ST. NEW YORK, NY


WING TITLE:


PROPOSED GRAND ST.
PLAN, ELEVATION &
PHOTOGRAPHS

PROJECT# 08203 SHEET: 3 of 12

A-102.00

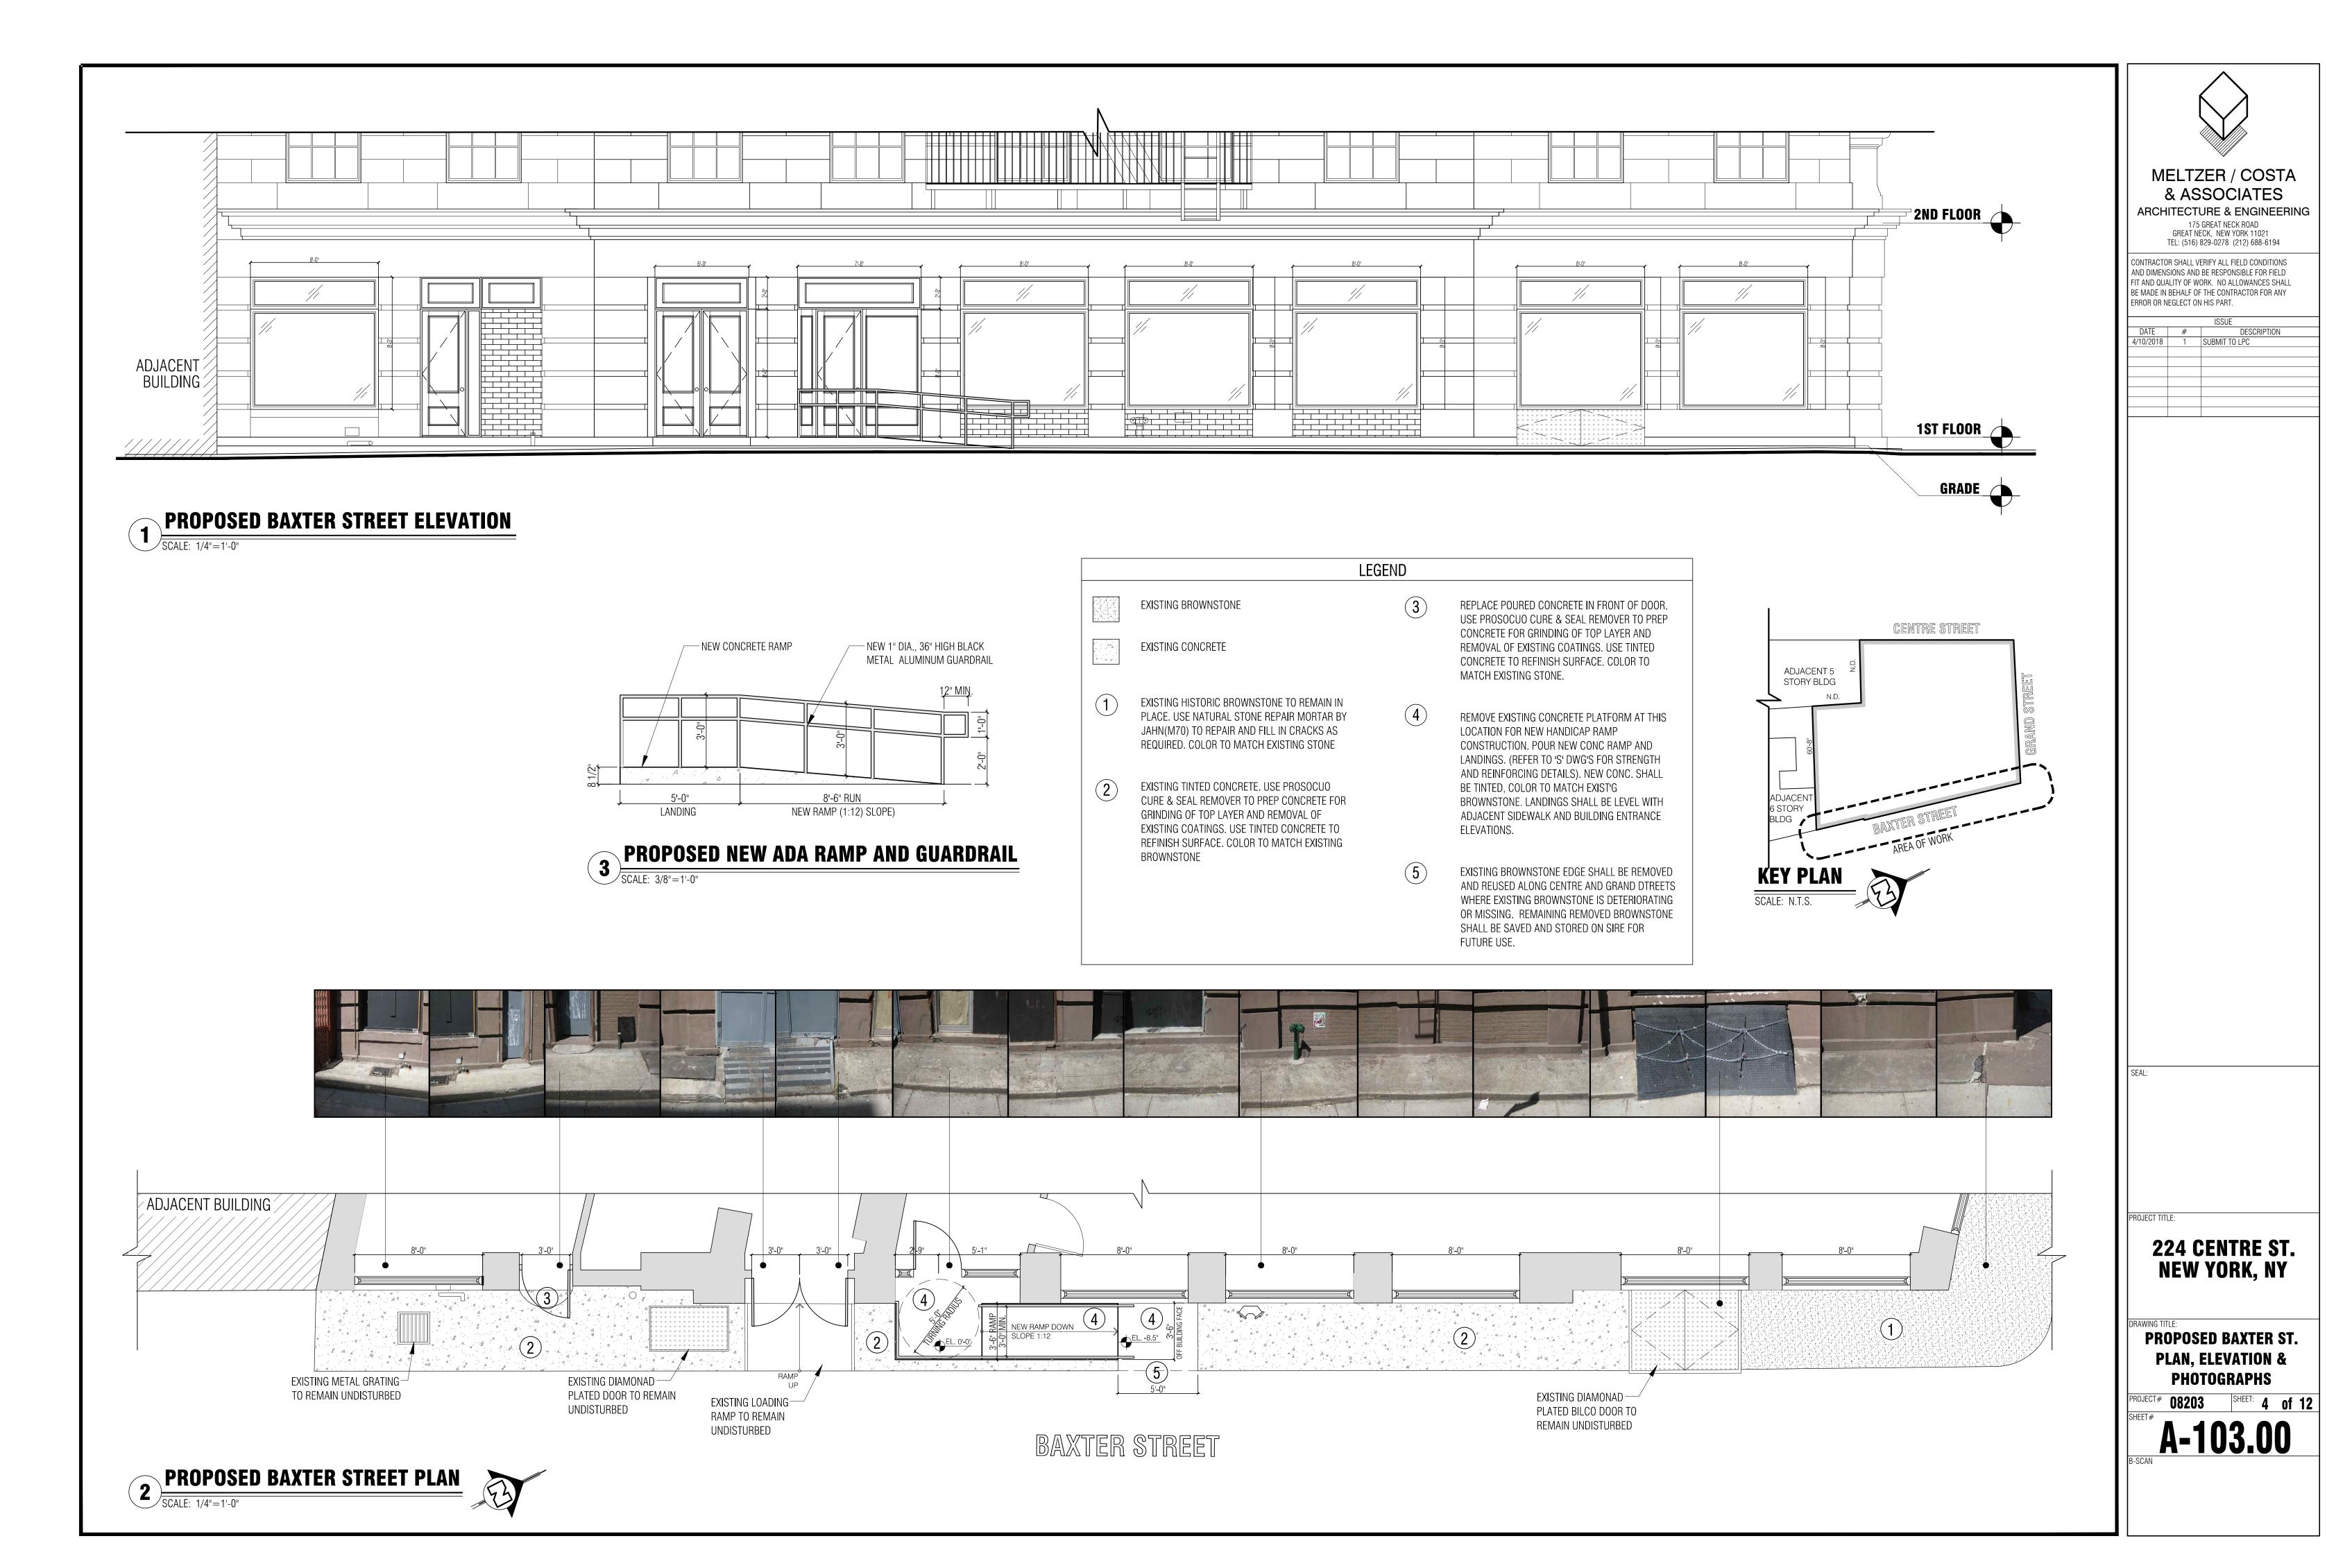

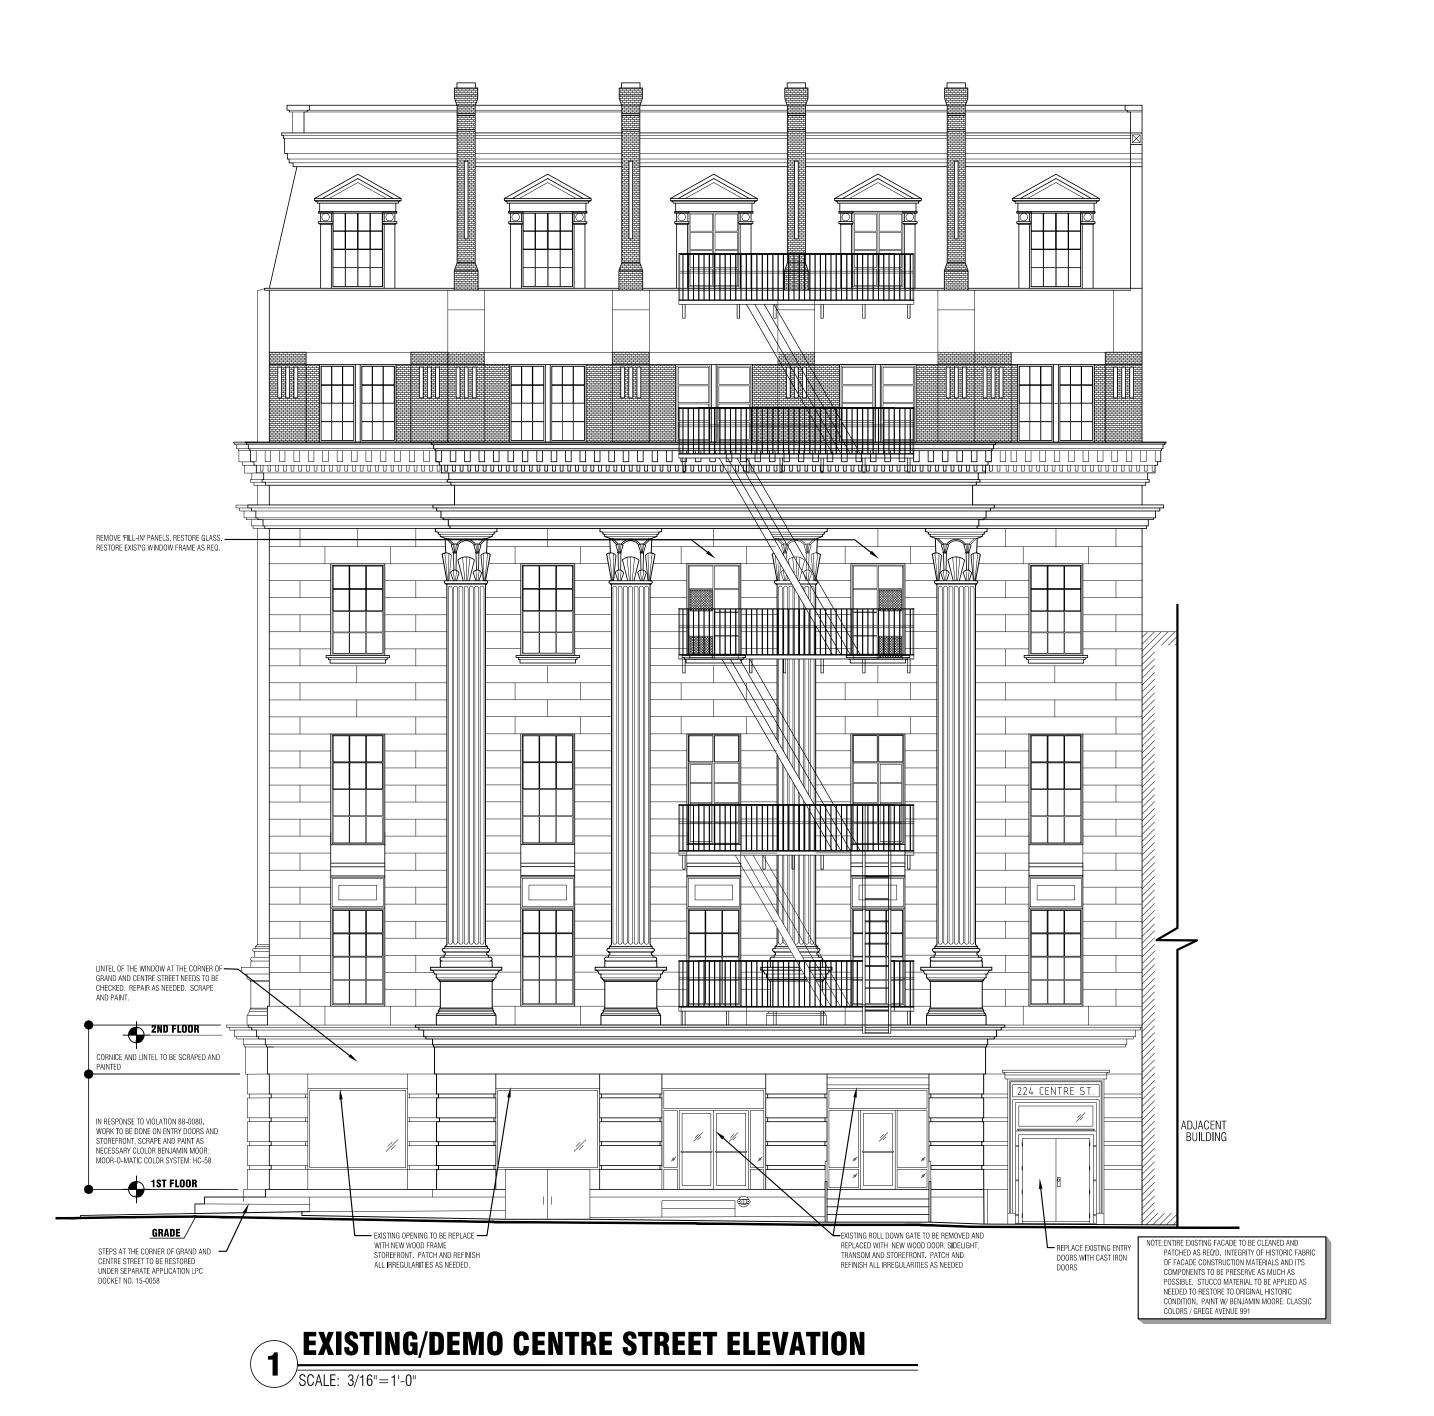

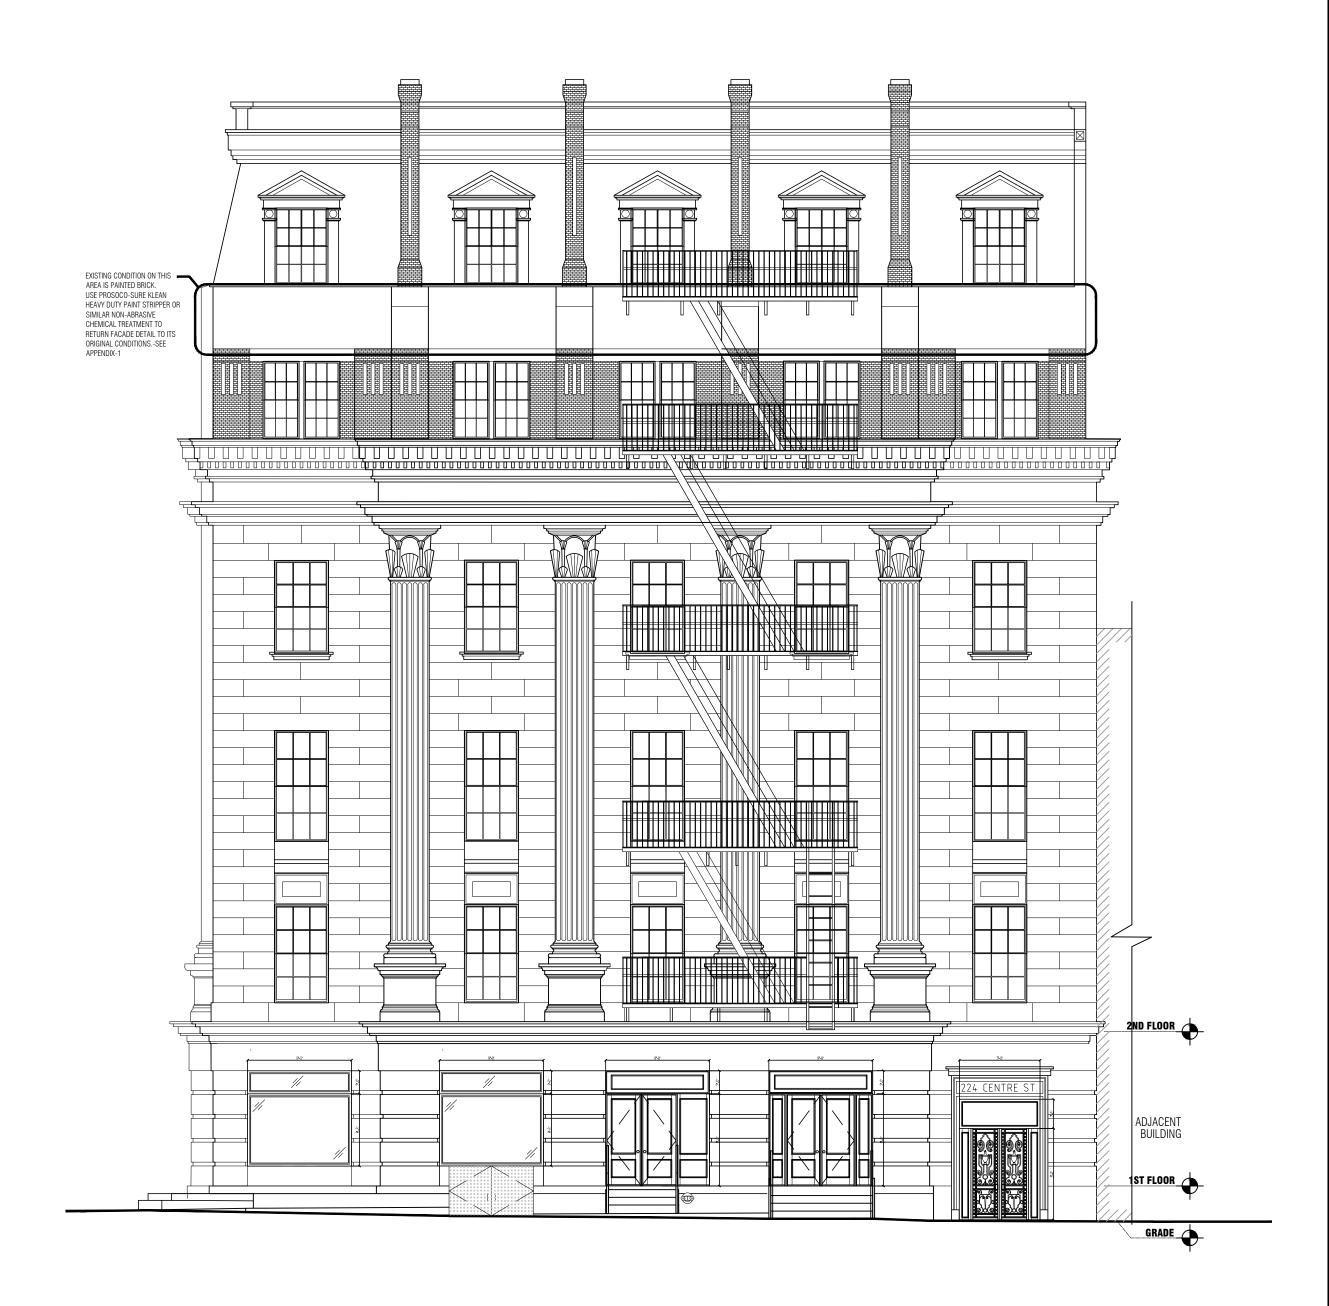

PROPOSED CENTRE STREET ELEVATION

SCALE: 3/32"=1'-0"

MELTZER / COSTA & ASSOCIATES ARCHITECTURE & ENGINEERING

175 GREAT NECK ROAD
GREAT NECK, NEW YORK 11021
TEL: (516) 829-0278 (212) 688-6194

CONTRACTOR SHALL VERIFY ALL FIELD CONDITIONS
AND DIMENSIONS AND BE RESPONSIBLE FOR FIELD
FIT AND QUALITY OF WORK. NO ALLOWANCES SHALL
BE MADE IN BEHALF OF THE CONTRACTOR FOR ANY

ERROR OR NEGLECT ON HIS PART.

ISSUE

DATE # DESCRIPTION

4/10/2018 1 SUBMIT TO LPC

SEAL:


ROJECT TITL


224 CENTRE ST. NEW YORK, NY

EXISTING & PROPOSED CENTRE ST. ELEVATION

PROJECT# **08203** SHEET: **5 of 12**


A-201.00

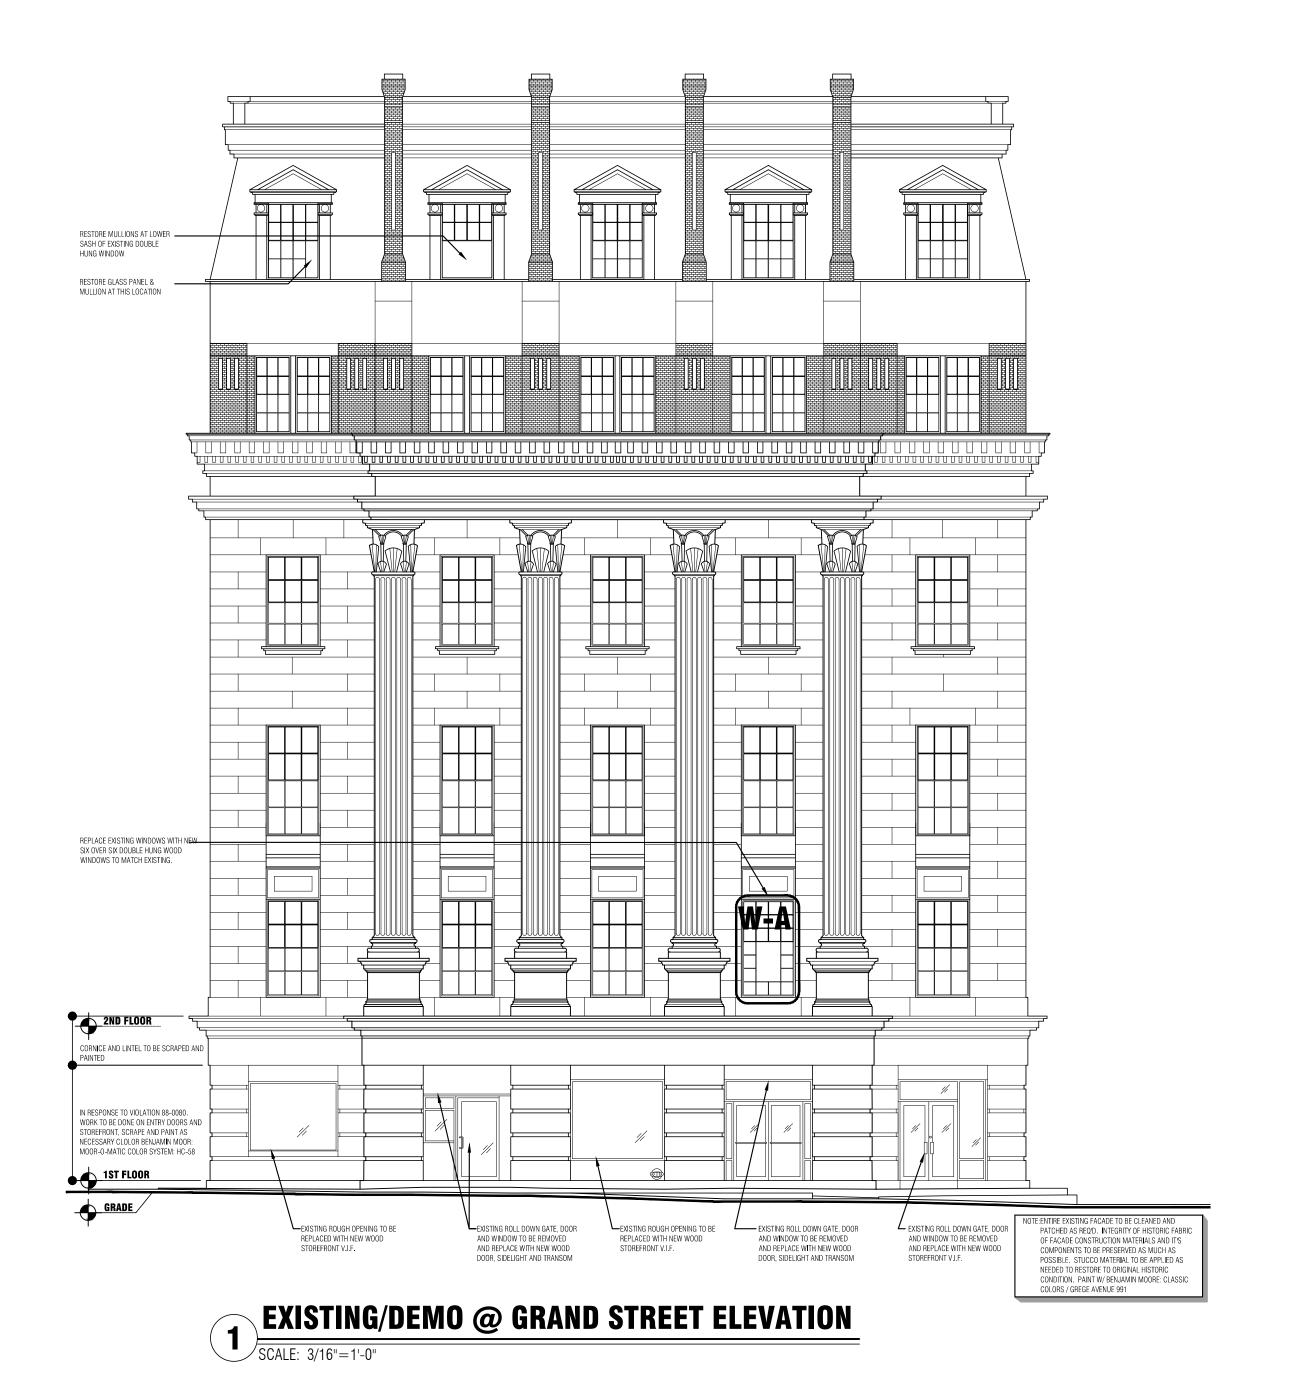

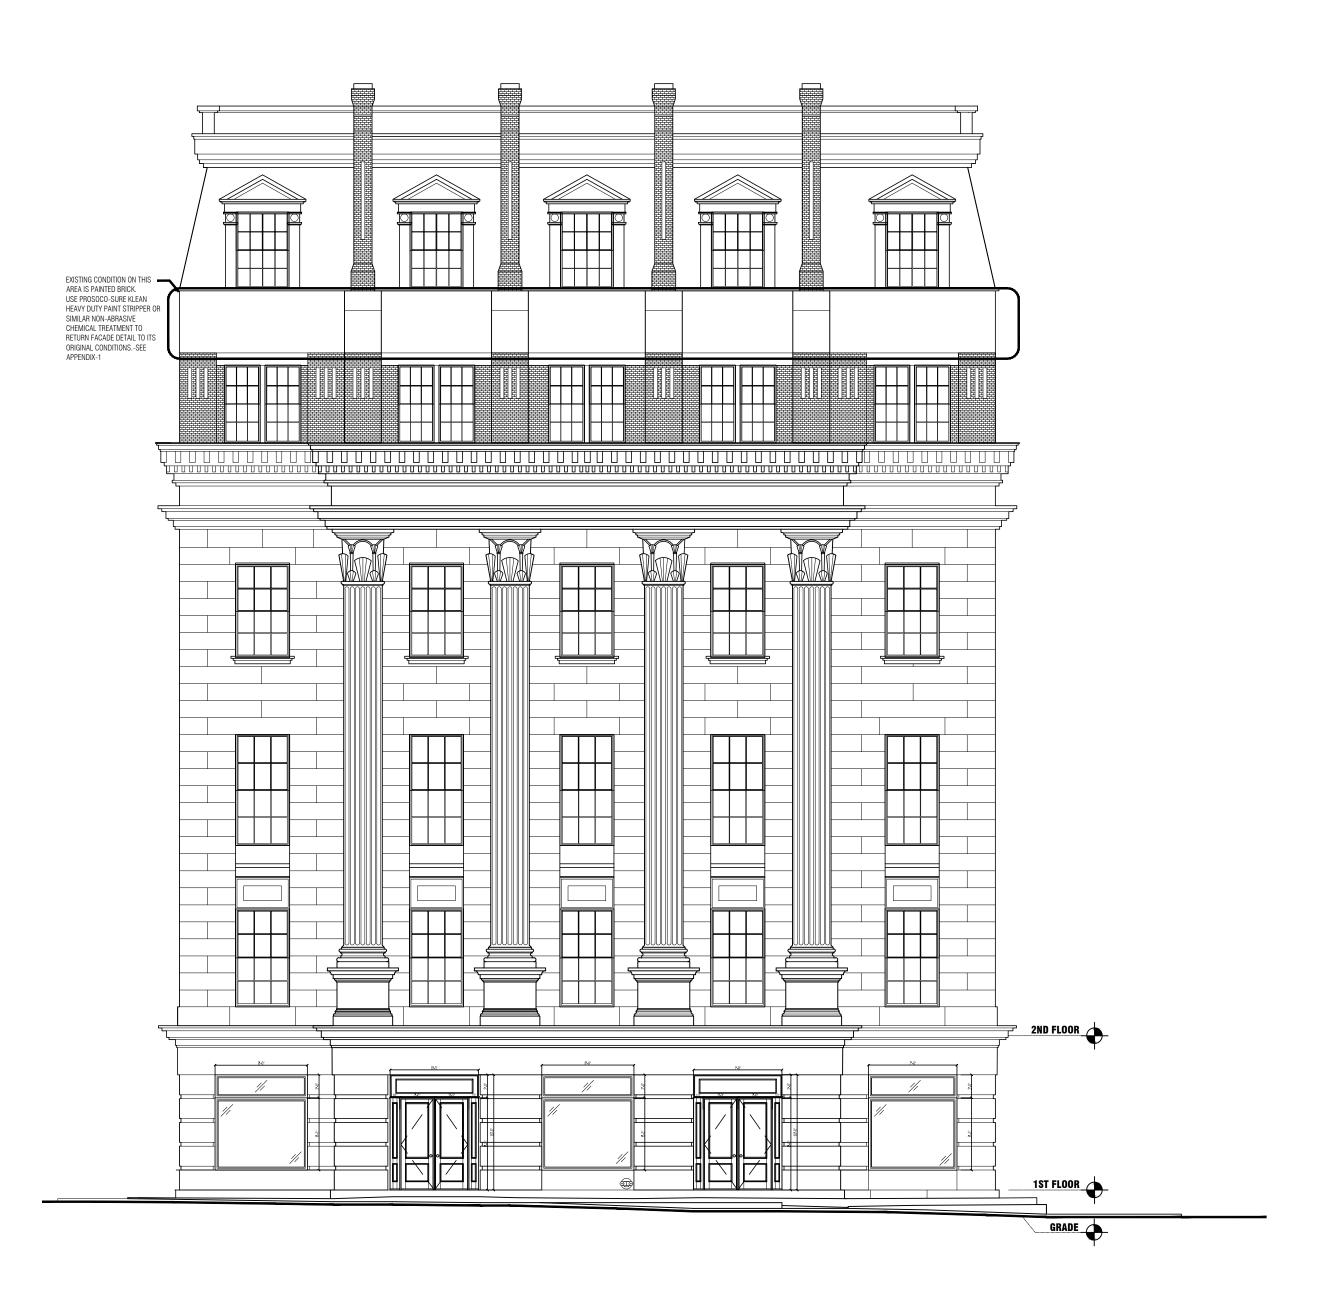

PROPOSED ELEVATION @ GRAND STREET

SCALE: 3/32"=1'-0"

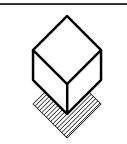

MELTZER / COSTA & ASSOCIATES ARCHITECTURE & ENGINEERING

175 GREAT NECK ROAD GREAT NECK, NEW YORK 11021 TEL: (516) 829-0278 (212) 688-6194

CONTRACTOR SHALL VERIFY ALL FIELD CONDITIONS AND DIMENSIONS AND BE RESPONSIBLE FOR FIELD FIT AND QUALITY OF WORK. NO ALLOWANCES SHALL BE MADE IN BEHALF OF THE CONTRACTOR FOR ANY ERROR OR NEGLECT ON HIS PART.

ı			ISSUE
ı	DATE	#	DESCRIPTION
ı	4/10/2018	1	SUBMIT TO LPC
ı			
ı			
ı			
ı			
ı			
ı			
ı			

PROJECT TITLE:

224 CENTRE ST. NEW YORK, NY


EXISTING& PROPOSED GRAND ST. ELEVATION


08203


6 of 12


A-202.00



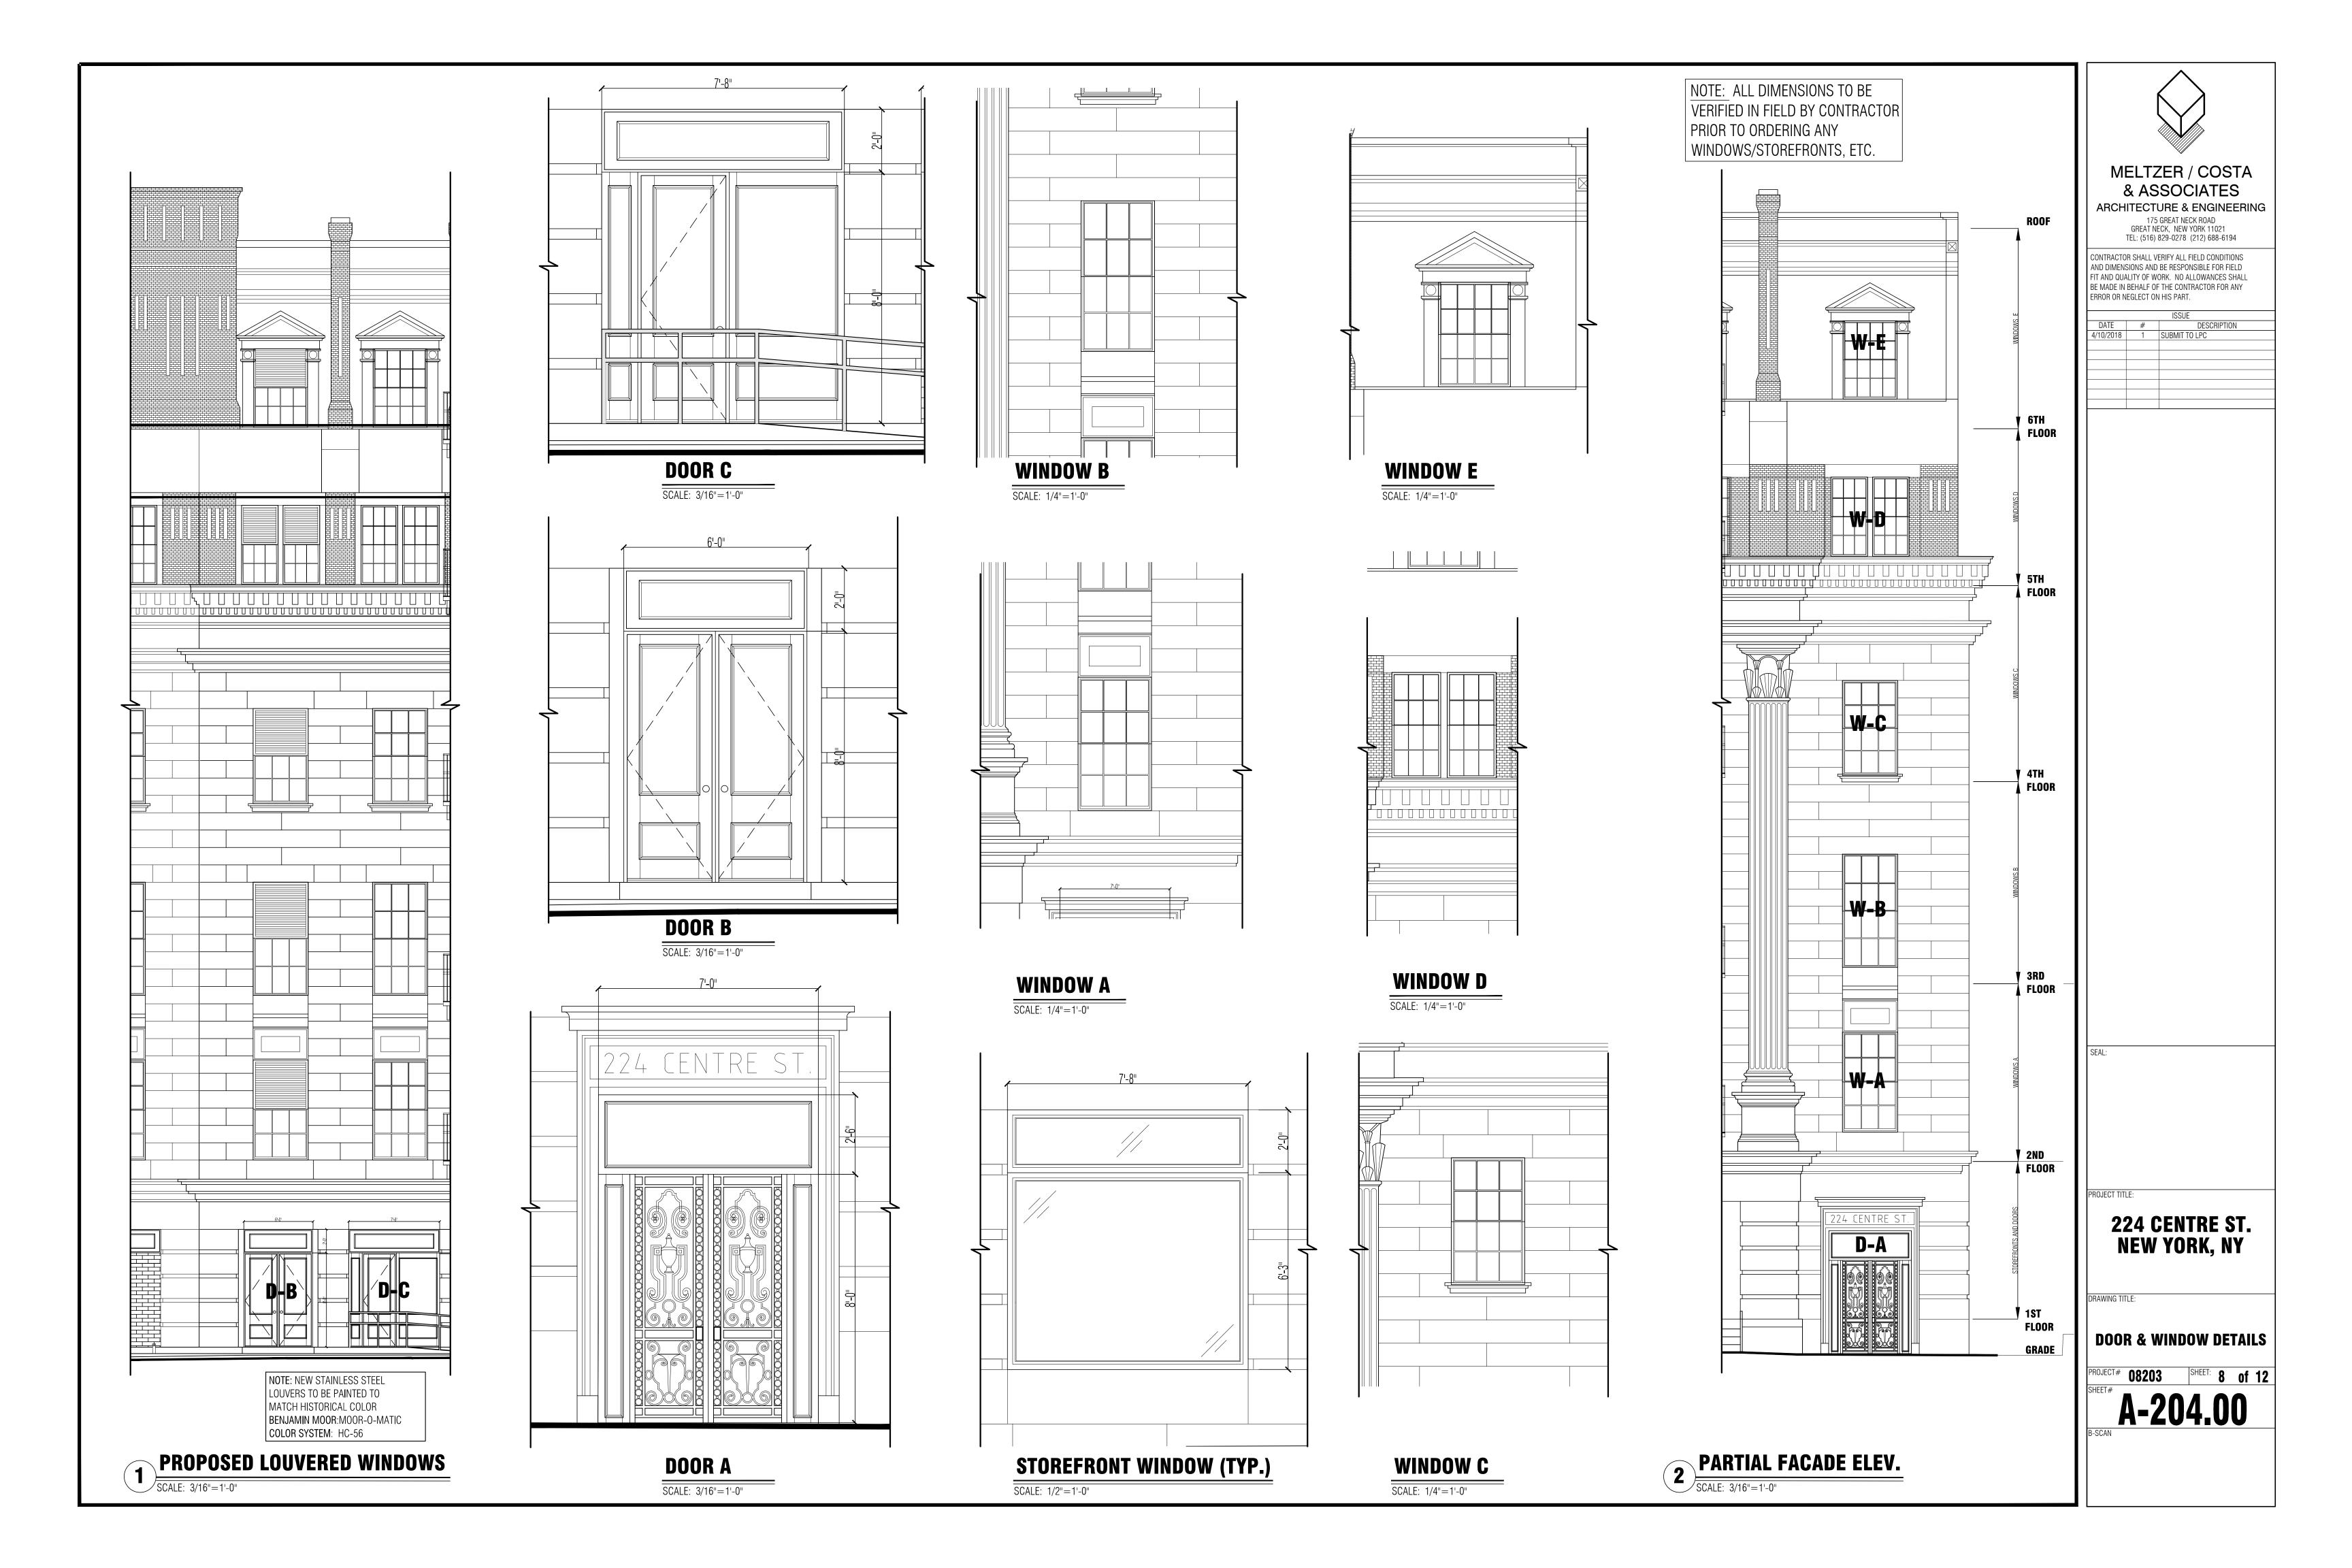

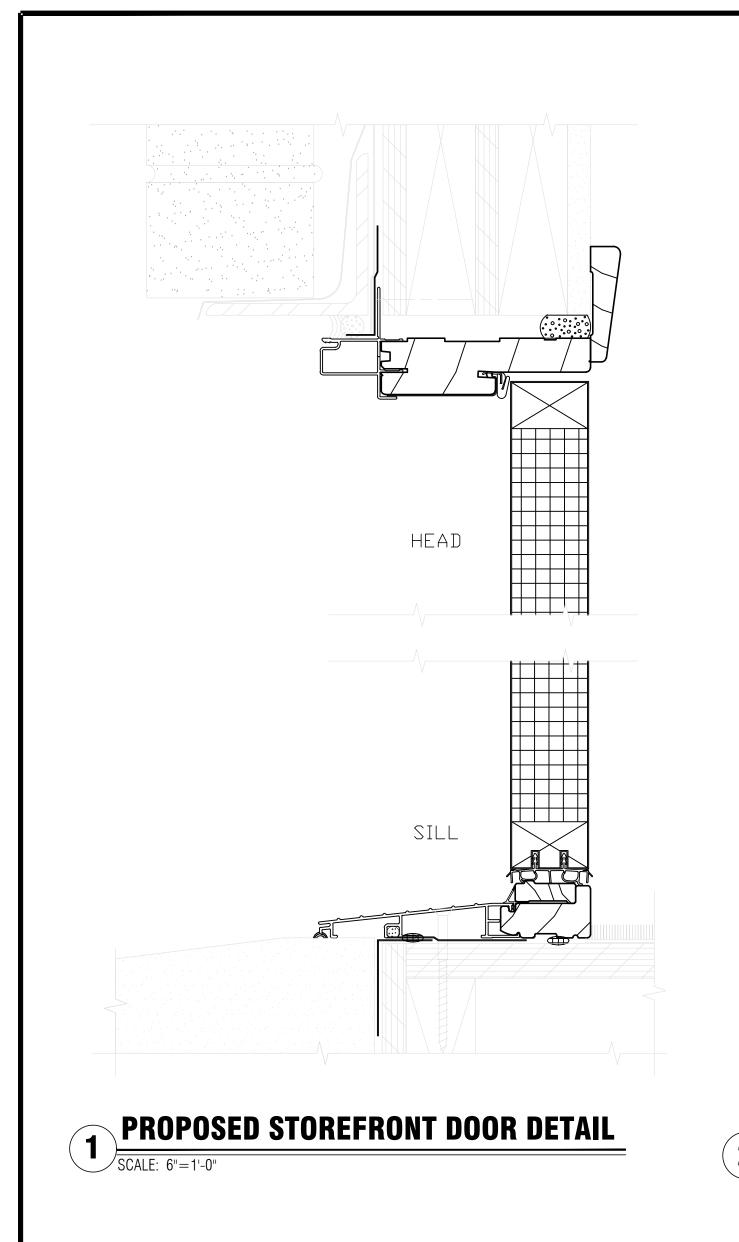

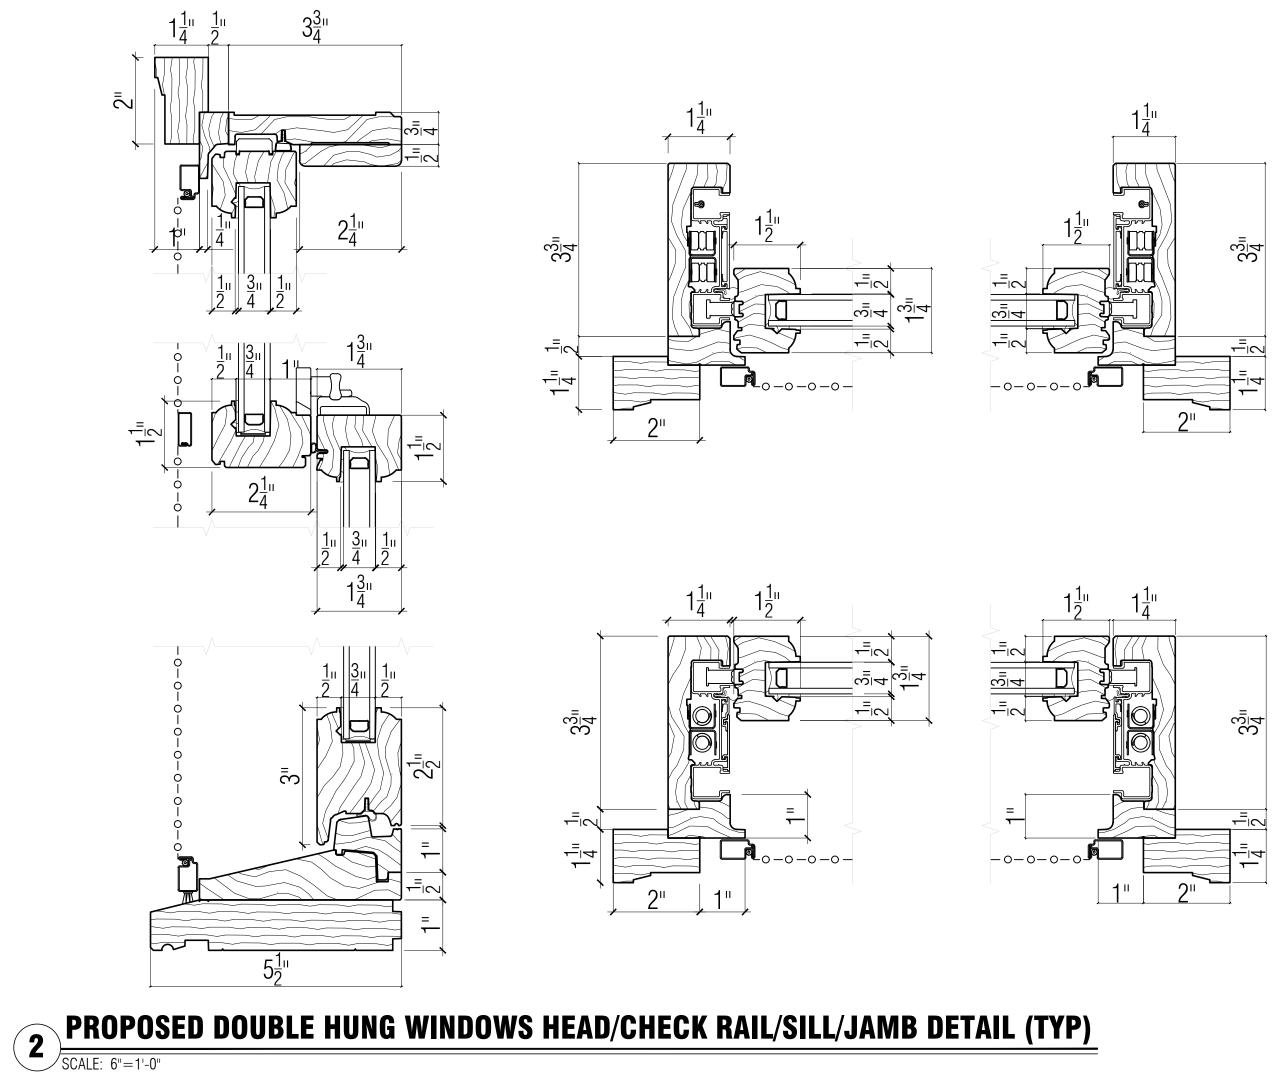

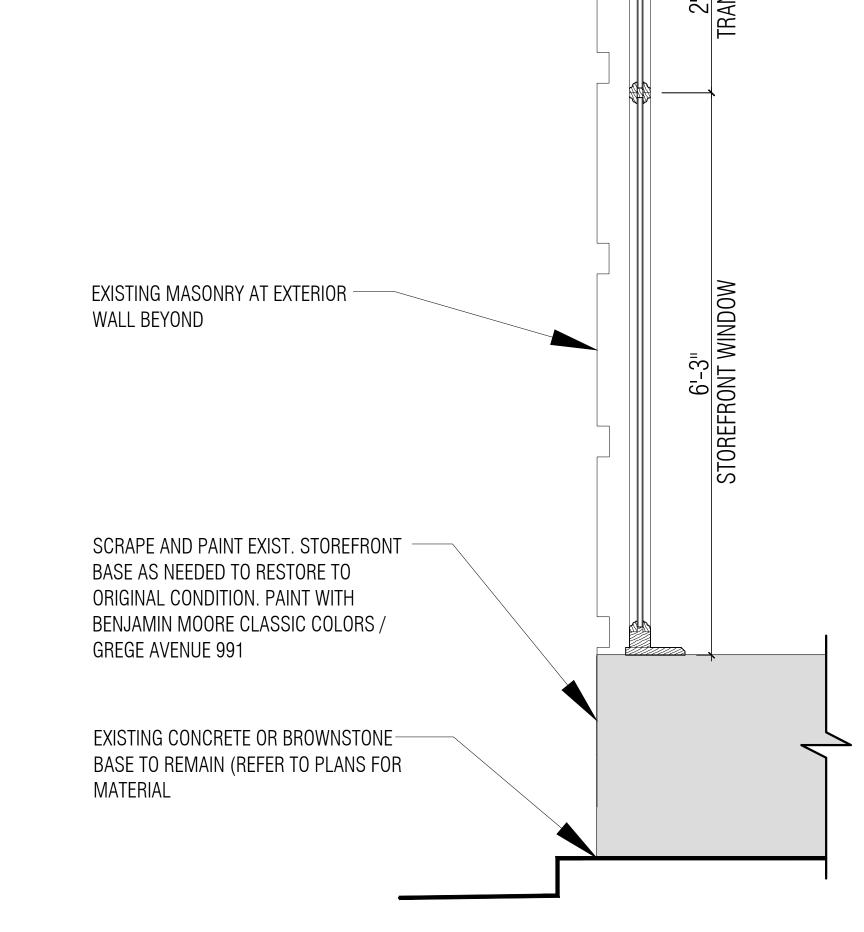

EXISTING CORNICE TO BE SCRAPED AND

PAINT WITH BENJAMIN MOOR CLASSIC

NEW WOOD STOREFRONT SYSTEM WITH


SURFACE. DESIGN TO MATCH HISTORIC

DOCUMENTATION OF BUILDING

TEMPERED LAMINATED INSULATED GLAZING WITH ULTRA CLEAR LOW-E COATING ON #3

COLORS / GRECE AVENUE 991

PAINTED. RESTORE TO ORIGINAL CONDITION.

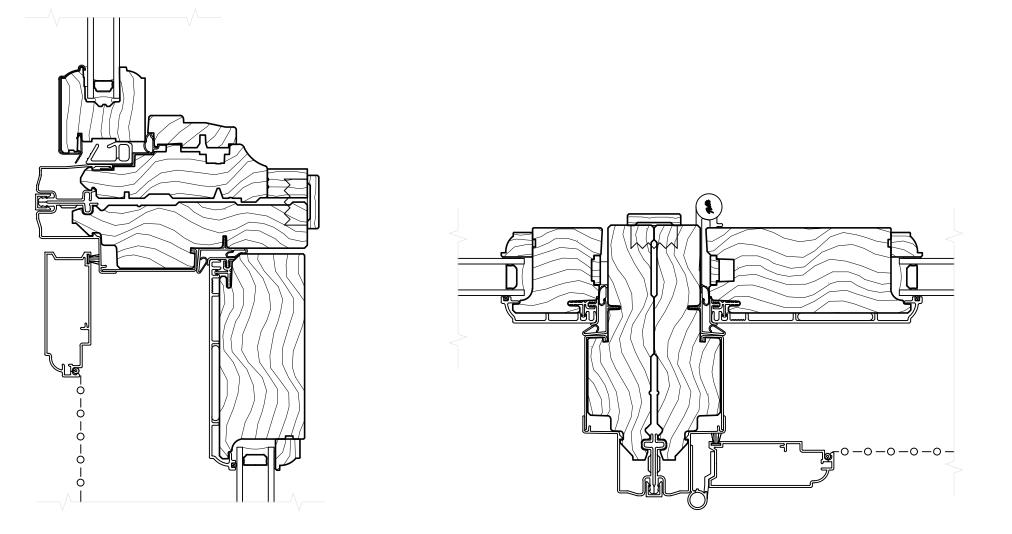


PROPOSED DOOR/TRANSOM HEAD/SILL/JAMB DETAIL

SCALE: 6"=1'-0"

PROPOSED STOREFRONT WINDOW DETAIL (TYP.)

SCALE: 1"=1'-0"

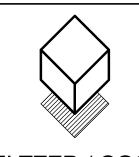

MELTZER / COSTA & ASSOCIATES ARCHITECTURE & ENGINEERING 175 GREAT NECK ROAD GREAT NECK, NEW YORK 11021 TEL: (516) 829-0278 (212) 688-6194

CONTRACTOR SHALL VERIFY ALL FIELD CONDITIONS AND DIMENSIONS AND BE RESPONSIBLE FOR FIELD FIT AND QUALITY OF WORK. NO ALLOWANCES SHALL BE MADE IN BEHALF OF THE CONTRACTOR FOR ANY ERROR OR NEGLECT ON HIS PART.

DATE # DESCRIPTION

4/10/2018 1 SUBMIT TO LPC

PROJECT TITLE:

224 CENTRE ST. NEW YORK, NY

DRAWING TITLE:

DOOR & WINDOW DETAILS

PROJECT# 08203 SHEET: 10 of 12 SHEET#

A-301.00

EXAMPLES OF LANDMARK BUILDINGS WITH CAST IRON DOORS



NYC MUNICIPAL LIBRARY - 1 ELK STREET ENTRANCE



FORMERLY NYC POLICE HEADQUARTERS - 240 CENTRE STREET



224 CENTRE STREET - EXISTING MAIN ENTRANCE



SUPER IMPOSED PROPOSED CAST IRON DOORS ON EXISTING BUILDING



LPC PRESENTATION

PROPOSED CAST IRON DOORS

SCALE: 1/4"=1'-0"

PROPOSED CAST IRON DOORS

224 CENTRE ST.

CAST IRON DOORS & OTHER LANDMARK **BUILDINGS**





224 CENTRE STREET NEW YORK, NY



